
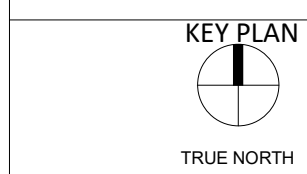


SITE PHASING:	
	PHASE 1* - DC 1 & DC 2: GENERAL SITE WORKS
	PHASE 1* - SUB STATION SUBJECT OF SEPARATE APPLICATION
	PHASE 2* - DC 3 & DC 5
	PHASE 3* - DC 4 & DC 6
	ON-SITE CONSTRUCTION COMPOUND
	TEMPORARY CONSTRUCTION ACCESS
DC	PROPOSED DATA CENTRE
AGI	PROPOSED ABOVE GROUND INSTALLATIONS
DH	PROPOSED DISTRICT HEATING
GNI	PROPOSED ACCESS TO GAS NETWORKS IRELAND

* Note: Please refer to Outline Construction Traffic Management Plan (OCTMP) 10360452-HDR-XX-XX-RP-T-000002 for anticipated Construction Program.

All trees/hedges to be retained are to be protected in accordance with BS 5837:2012. Trees in relation to design, demolition & construction. Prior to the commencement of any work, or any materials being brought on site as part of Phase 1, existing trees to be retained are to be protected with temporary fencing. These shall be maintained in good and effective condition until the work is completed. Allow for stabiliser struts to secure fence for duration of construction. Fully remove when construction is complete and site is fully reinstated. Please refer drawing BSM-ZZ-ZZ-DR-L-0211-0214 for further detail.

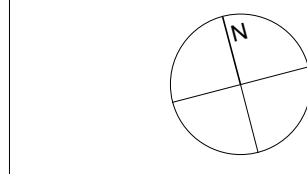

Rev.	Date	Description
P08	03/11/2023	PLANNING ISSUE
P07	02/08/2023	PLANNING ISSUE
P06	11/07/2023	PLANNING ISSUE
P05	02/06/2023	DRAFT PLANNING ISSUE
P04	26/04/2023	STAGE 2 ISSUE
P03	10/03/2023	DRAFT ISSUE
P02	28/02/2023	DESIGN FREEZE - STAGE 2
P01	24/02/2023	Pre-Planning

STATUS	PLANNING
PROJECT	HERBATA DATA CENTRE CAMPUS
PROJECT ADDRESS	NAAS, CO. KILDARE
DWG TITLE	SITE PHASING PLAN

DWG NO.	22217-RKD-ZZ-ZZ-DR-A-1030
REV.	SUBMITALITY PROJECT NO. 22217
P08	S3 SCALE 1:1500
DATE	03/11/2023 DRW RCD CHK KOIS



ESB SUB STATION SUBJECT OF SEPARATE SID APPLICATION.



ON SITE CONSTRUCTION COMPOUND - SEE ENGINEER DRAWINGS FOR FURTHER DETAILS.

TEMPORARY CONSTRUCTION ENTRANCE

A1030 - PROPOSED SITE PHASING PLAN
1 : 1500

- LEGEND**
1. PROPRIETARY INSULATED METAL CLADDING SYSTEM ON STEEL STRUCTURE (EUBOND-FLAT PROFILE PANELS OR OTHER APPROVED TO DATA HALL AREA. COLOUR TONE - MEDIUM DARK GREY.
 2. PROPRIETARY INSULATED METAL CLADDING SYSTEM ON STEEL STRUCTURE (EUBOND-FLAT PROFILE PANELS OR OTHER APPROVED TO ADMIN AREA. COLOUR TONE - MEDIUM DARK GREY.
 3. PROPRIETARY INSULATED METAL CLADDING SYSTEM ON STEEL STRUCTURE (EUBOND-FLAT PROFILE PANELS OR OTHER APPROVED TO ADMIN AREA. COLOUR TONE - MEDIUM DARK GREY.
 4. PROPRIETARY INSULATED METAL CLADDING SYSTEM ON STEEL STRUCTURE (EUBOND-FLAT PROFILE PANELS OR OTHER APPROVED TO ADMIN AREA. COLOUR TONE - OFF-WHITE.
 5. PROPRIETARY INSULATED METAL CLADDING SYSTEM ON STEEL STRUCTURE (EUBOND-FLAT PROFILE PANELS OR OTHER APPROVED TO ADMIN AREA. COLOUR TONE - LIGHT GREY.
 6. SELECTED ALUMINIUM RAINSCREEN CLADDING SYSTEM OR OTHER APPROVED IN SELECTED COLOUR.
 7. SELECTED GLAZED CURTAIN WALL SYSTEM WITH CLAYED AND SPANREL PANELS IN SELECTED COLOUR.
 8. SELECTED VERTICAL ALUMINIUM FINS IN SELECTED COLOUR.
 9. SELECTED HORIZONTAL MICRO LOUVER SET INTO PANELS TO PLANT ROOM FACADE.
 10. SELECTED PARALON OR OTHER APPROVED ROOF FINISH LAG TO MANUFACTURERS SPECIFICATION ON STEEL STRUCTURE TO ENGINEERS FUTURE DETAILS.
 11. SELECTED MEDIUM ROOF FINISH ON BLUE ROOF ATTENUATION LAYER.
 12. ALUMINIUM CANOPY IN SELECTED COLOUR. COLOUR TONE - LIGHT GREY.
 13. 2.4m HIGH PALLSIDE SECURITY FENCE AROUND PLANT AREAS, DATA BUILDINGS AND ASSOCIATED STRUCTURES.
 14. 1.3m HIGH AGRICULTURAL TIMBER POST AND WIRE MESH FENCING TO WESTERN BOUNDARY FENCE.
 15. 1.2m HIGH TIMBER POST AND RAIL FENCE TO SURROUND FENCE.
 16. 2.4m HIGH PALLSIDE SECURITY FENCE AROUND ENTIRE SITE.
 17. SELECTED MEDIUM ROOF FINISH.
 18. EXTERNAL METAL LOUVER TO ACOUSTIC SCREEN WALL.
 19. ACOUSTIC PANEL.


- AREA LEGEND**
- ADMIN
 - BACK OF HOUSE
 - CIRCULATION
 - DATA HALL
 - EXTERNAL PLANT YARD
 - MECHANICAL/ELECTRICAL
 - STORAGE
 - PLANT YARD WALKWAYS (MIN. WIDTH 1500mm)

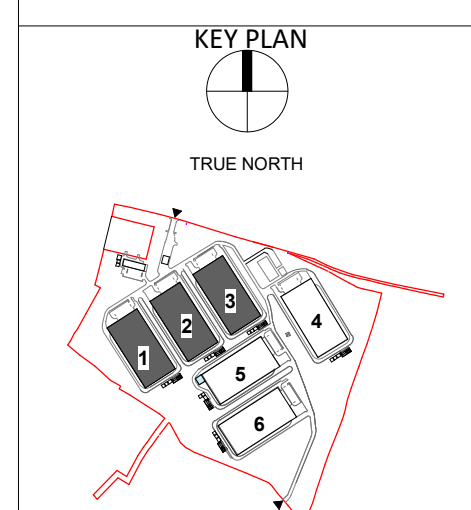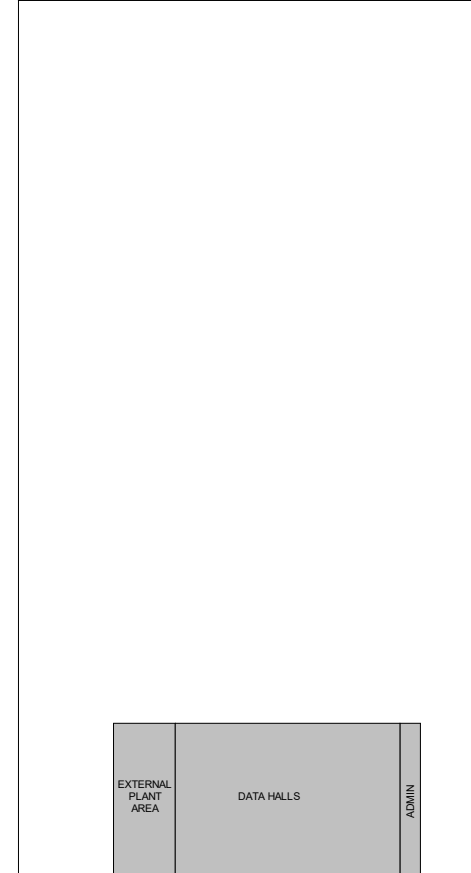

Rev.	Date	Description
P08	03/11/2023	PLANNING ISSUE
P07	02/08/2023	PLANNING ISSUE
P06	11/07/2023	PLANNING ISSUE
P05	02/06/2023	DRAFT PLANNING ISSUE
P04	26/05/2023	STAGE 2 ISSUE
P03	10/03/2023	DRAFT ISSUE
P02	28/02/2023	DESIGN FREEZE - STAGE 2
P01	14/02/2023	Pre-Planning

STATUS	PLANNING
PROJECT	HERBATA DATA CENTRE CAMPUS
PROJECT ADDRESS	NAAS, CO. KILDARE
DWG TITLE	DATA CENTRE - OVERALL GROUND FLOOR PLAN TYPE A



DWG NO.			
22217-RKD-ZZ-00-DR-A-1100			
REV.	SUITABILITY	PROJECT NO.	22217
P08	S3	SCALE	1:200
DATE	03/11/2023	DRW RCD	CHK KOS

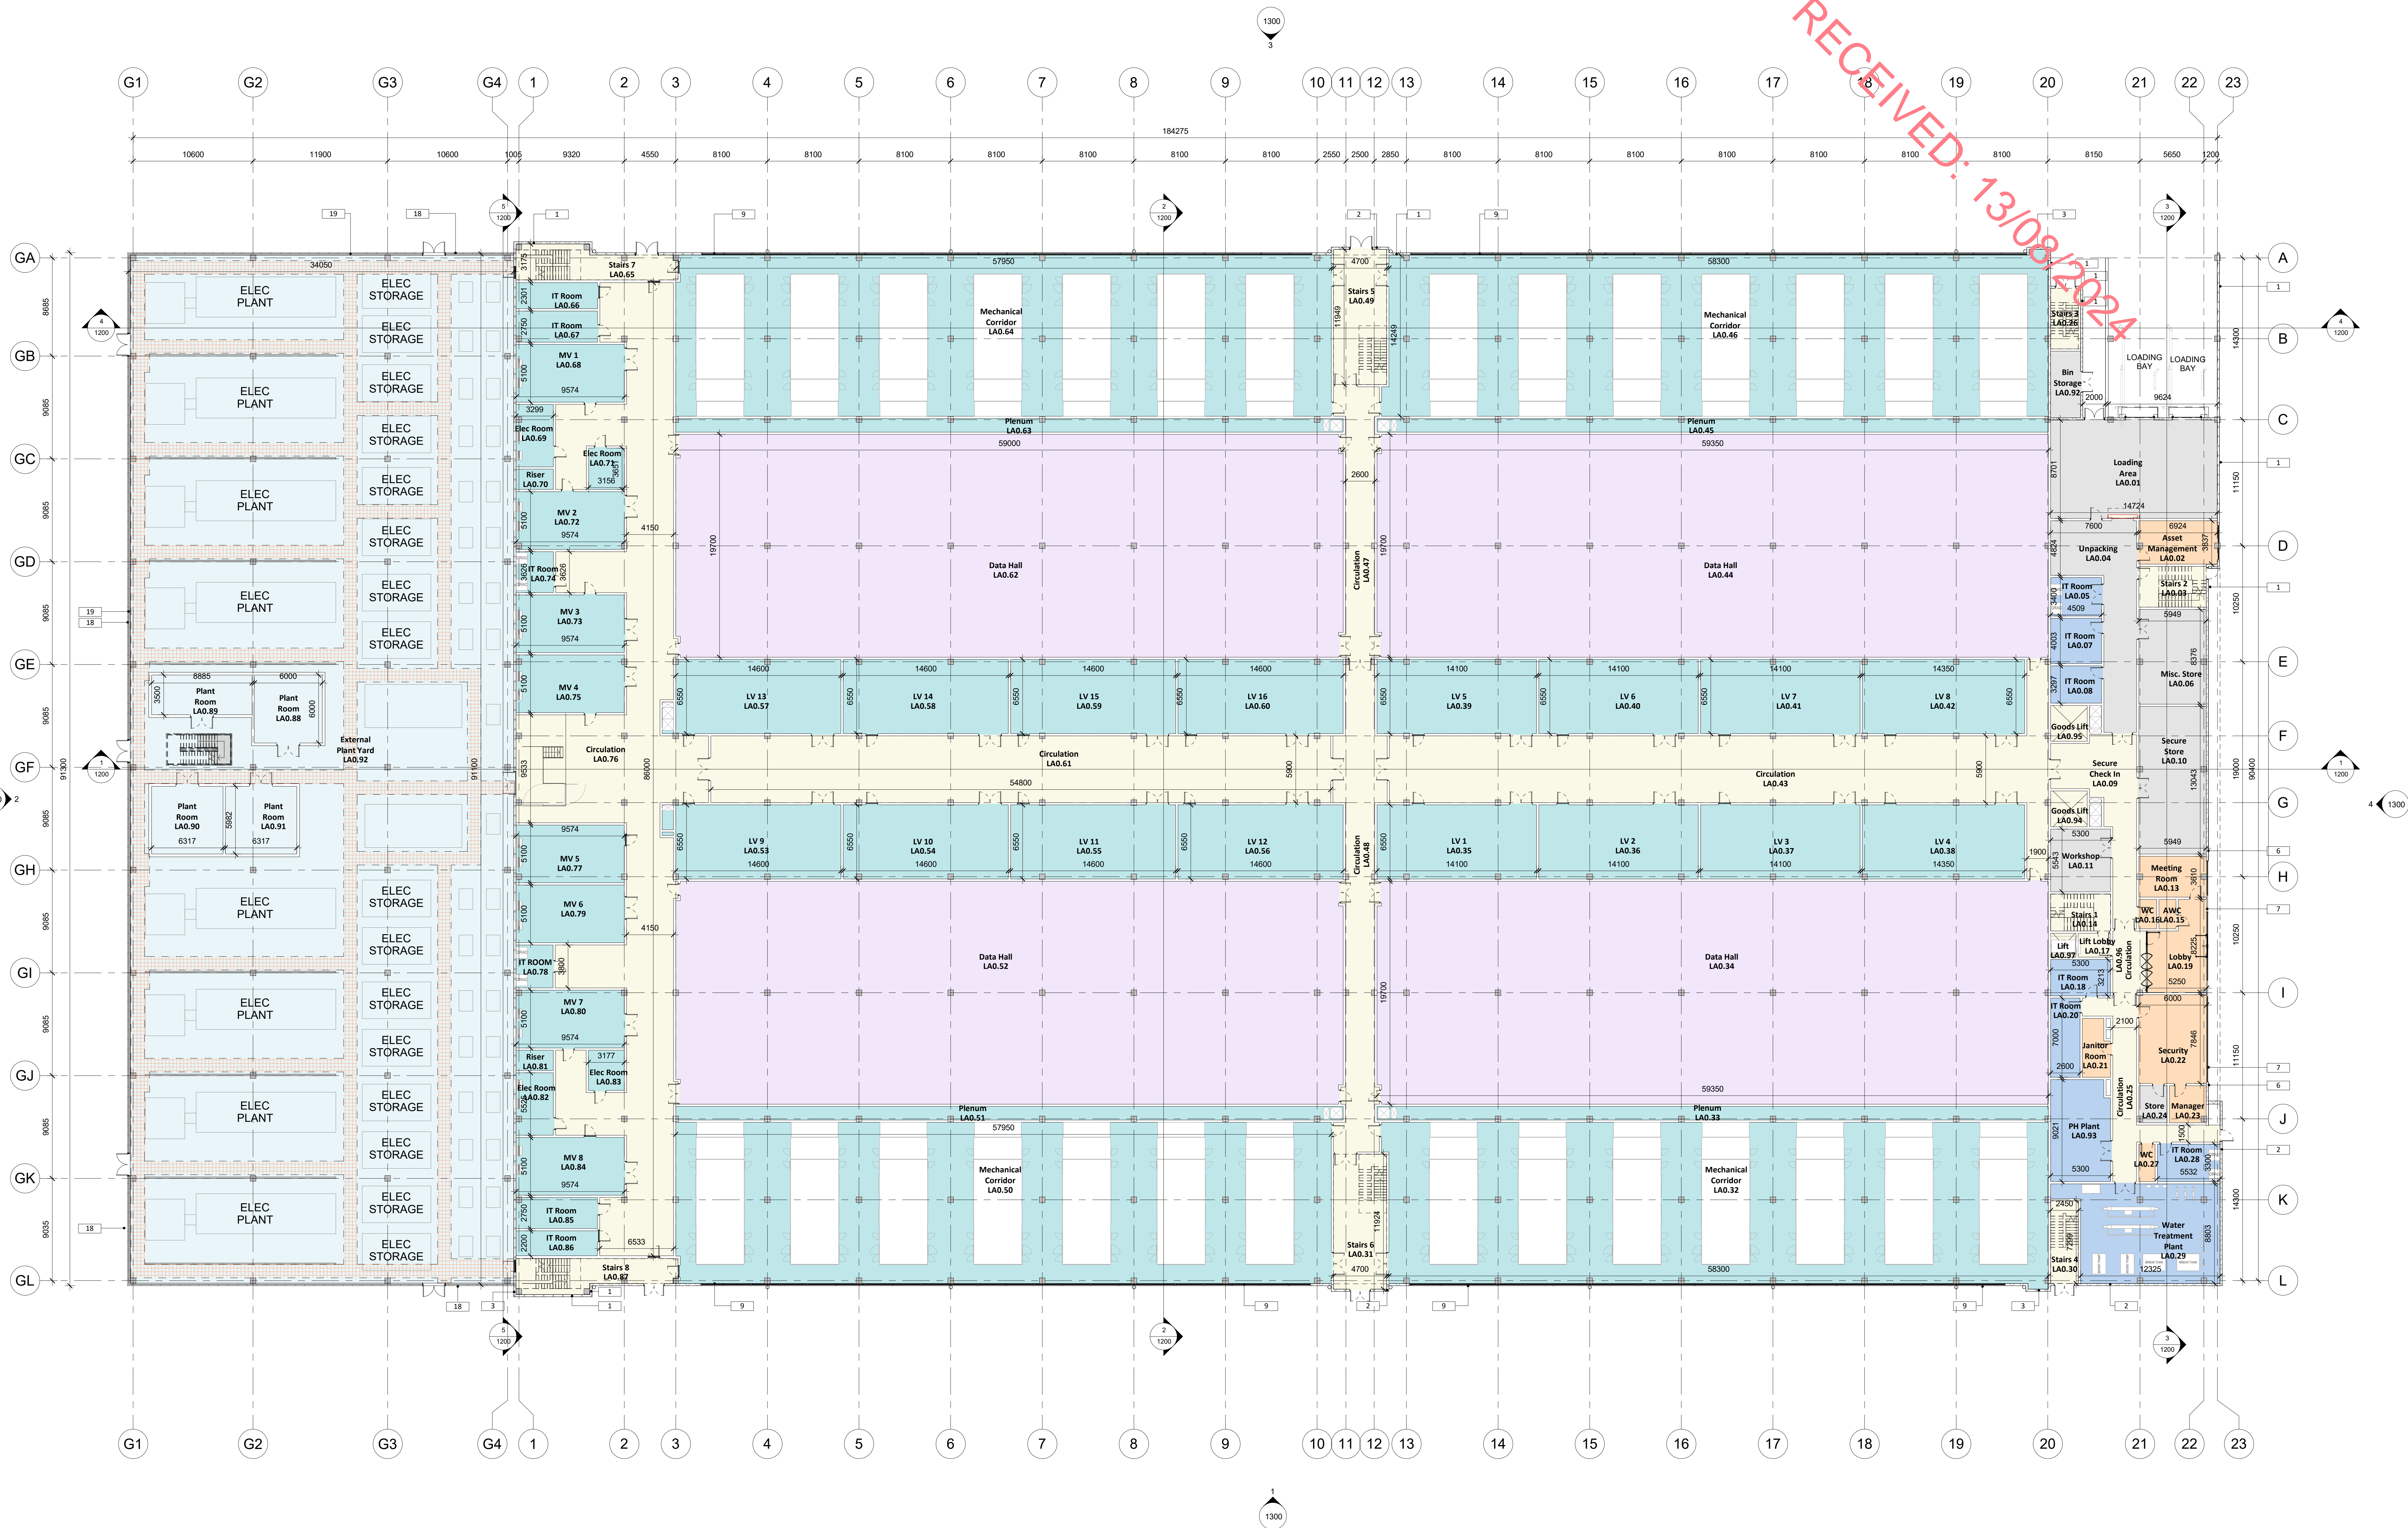

A1100_Overall Ground Floor Plan
1:200

- Notes:
1. PROPRIETARY INSULATED METAL CLADDING SYSTEM ON STEEL STRUCTURE (EUBROD) - FLAT PROFILE PANELS OR OTHER APPROVED TO ADMIN AREA. COLOUR TONE - MEDIUM GREY.
 2. PROPRIETARY INSULATED METAL CLADDING SYSTEM ON STEEL STRUCTURE (EUBROD) - FLAT PROFILE PANELS OR OTHER APPROVED TO ADMIN AREA. COLOUR TONE - MEDIUM GREY.
 3. PROPRIETARY INSULATED METAL CLADDING SYSTEM ON STEEL STRUCTURE (EUBROD) - FLAT PROFILE PANELS OR OTHER APPROVED TO ADMIN AREA. COLOUR TONE - MEDIUM GREY.
 4. PROPRIETARY INSULATED METAL CLADDING SYSTEM ON STEEL STRUCTURE (EUBROD) - FLAT PROFILE PANELS OR OTHER APPROVED TO ADMIN AREA. COLOUR TONE - OFF-WHITE.
 5. PROPRIETARY INSULATED METAL CLADDING SYSTEM ON STEEL STRUCTURE (EUBROD) - FLAT PROFILE PANELS OR OTHER APPROVED TO ADMIN AREA. COLOUR TONE - LIGHT GREY.
 6. SELECTED ALUMINIUM RANGECREEK CLADDING SYSTEM OR OTHER APPROVED IN SELECTED COLOUR AROUND ENTRANCE.
 7. SELECTED ALUMINIUM RANGECREEK CLADDING SYSTEM OR OTHER APPROVED IN SELECTED COLOUR.
 8. SELECTED VERTICAL ALUMINIUM FINS IN SELECTED COLOUR.
 9. SELECTED HORIZONTAL MICRO LOUVRES SET INTO PANELS TO PLANT ROOM FACADE.
 10. SELECTED PARALON OR OTHER APPROVED ROOF FINISH LAG TO MANUFACTURER'S SPECIFICATION ON STEEL STRUCTURE TO ENGINEER'S FUTURE DETAILS.
 11. SELECTED MEDIUM ROOF FINISH ON BLUE ROOF ATTENUATION LAYER.
 12. ALUMINIUM CANOPY IN SELECTED COLOUR. COLOUR TONE - LIGHT GREY.
 13. 4m HIGH PALLIAD SECURITY FENCE AROUND PLANT AREAS, DATA BUILDINGS AND ASSOCIATED STRUCTURE.
 14. 1.2m HIGH AGRICULTURAL TIMBER POST AND WIRE MESH FENCING TO WESTERN BOUNDARY HEDGE.
 15. 1.2m HIGH TIMBER POST AND RAIL FENCE TO SURROUND FARMER.
 16. 2.4m HIGH PALLIAD SECURITY FENCE AROUND ENTIRE SITE.
 17. SELECTED MEDIUM ROOF FINISH.
 18. EXTERNAL METAL LOUVER TO ACOUSTIC SCREEN WALL.
 19. ACOUSTIC PANEL.

- AREA LEGEND
- ADMIN
 - BACK OF HOUSE
 - CIRCULATION
 - DATA HALL
 - EXTERNAL PLANT YARD
 - EXTERNAL PLANT YARD
 - MECHANICAL/ELECTRICAL
 - STORAGE
 - PLANT YARD WALKWAYS (MIN. WIDTH 1500mm)

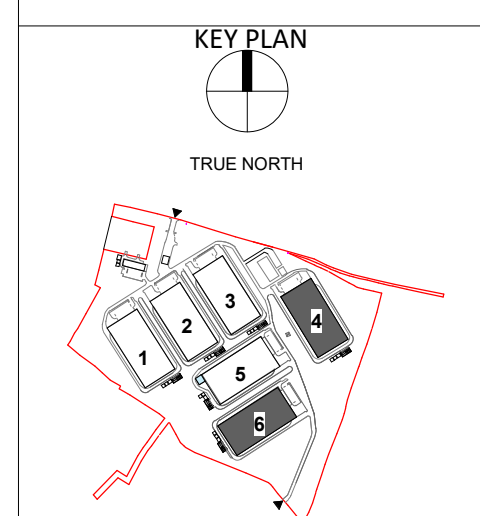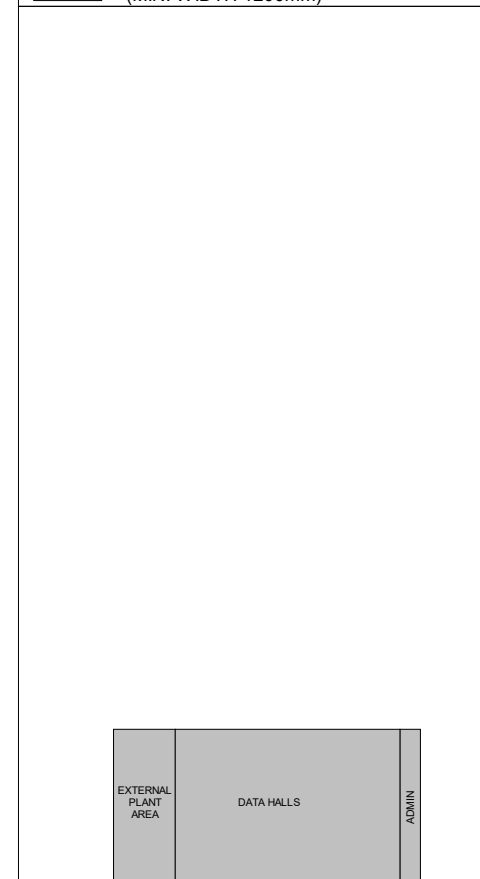

Rev.	Date	Description
P04	03/11/2023	PLANNING ISSUE
P03	02/08/2023	PLANNING ISSUE
P02	11/03/2023	PLANNING ISSUE
P01	03/06/2023	DRIFT PLANNING ISSUE

STATUS: PLANNING

PROJECT: HERBATA DATA CENTRE CAMPUS

PROJECT ADDRESS: NAAS, CO. KILDARE

DWG TITLE: DATA CENTRE - OVERALL GROUND FLOOR PLAN TYPE B

DWG NO: 22217-RKD-ZZ-00-DR-A-1105

REV: P04 S3 SCALE: 1:200


DATE: 03/11/2023 DWG: RCD CHK: KOS

RKD

BSM

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RECEIVED: 13/08/2023

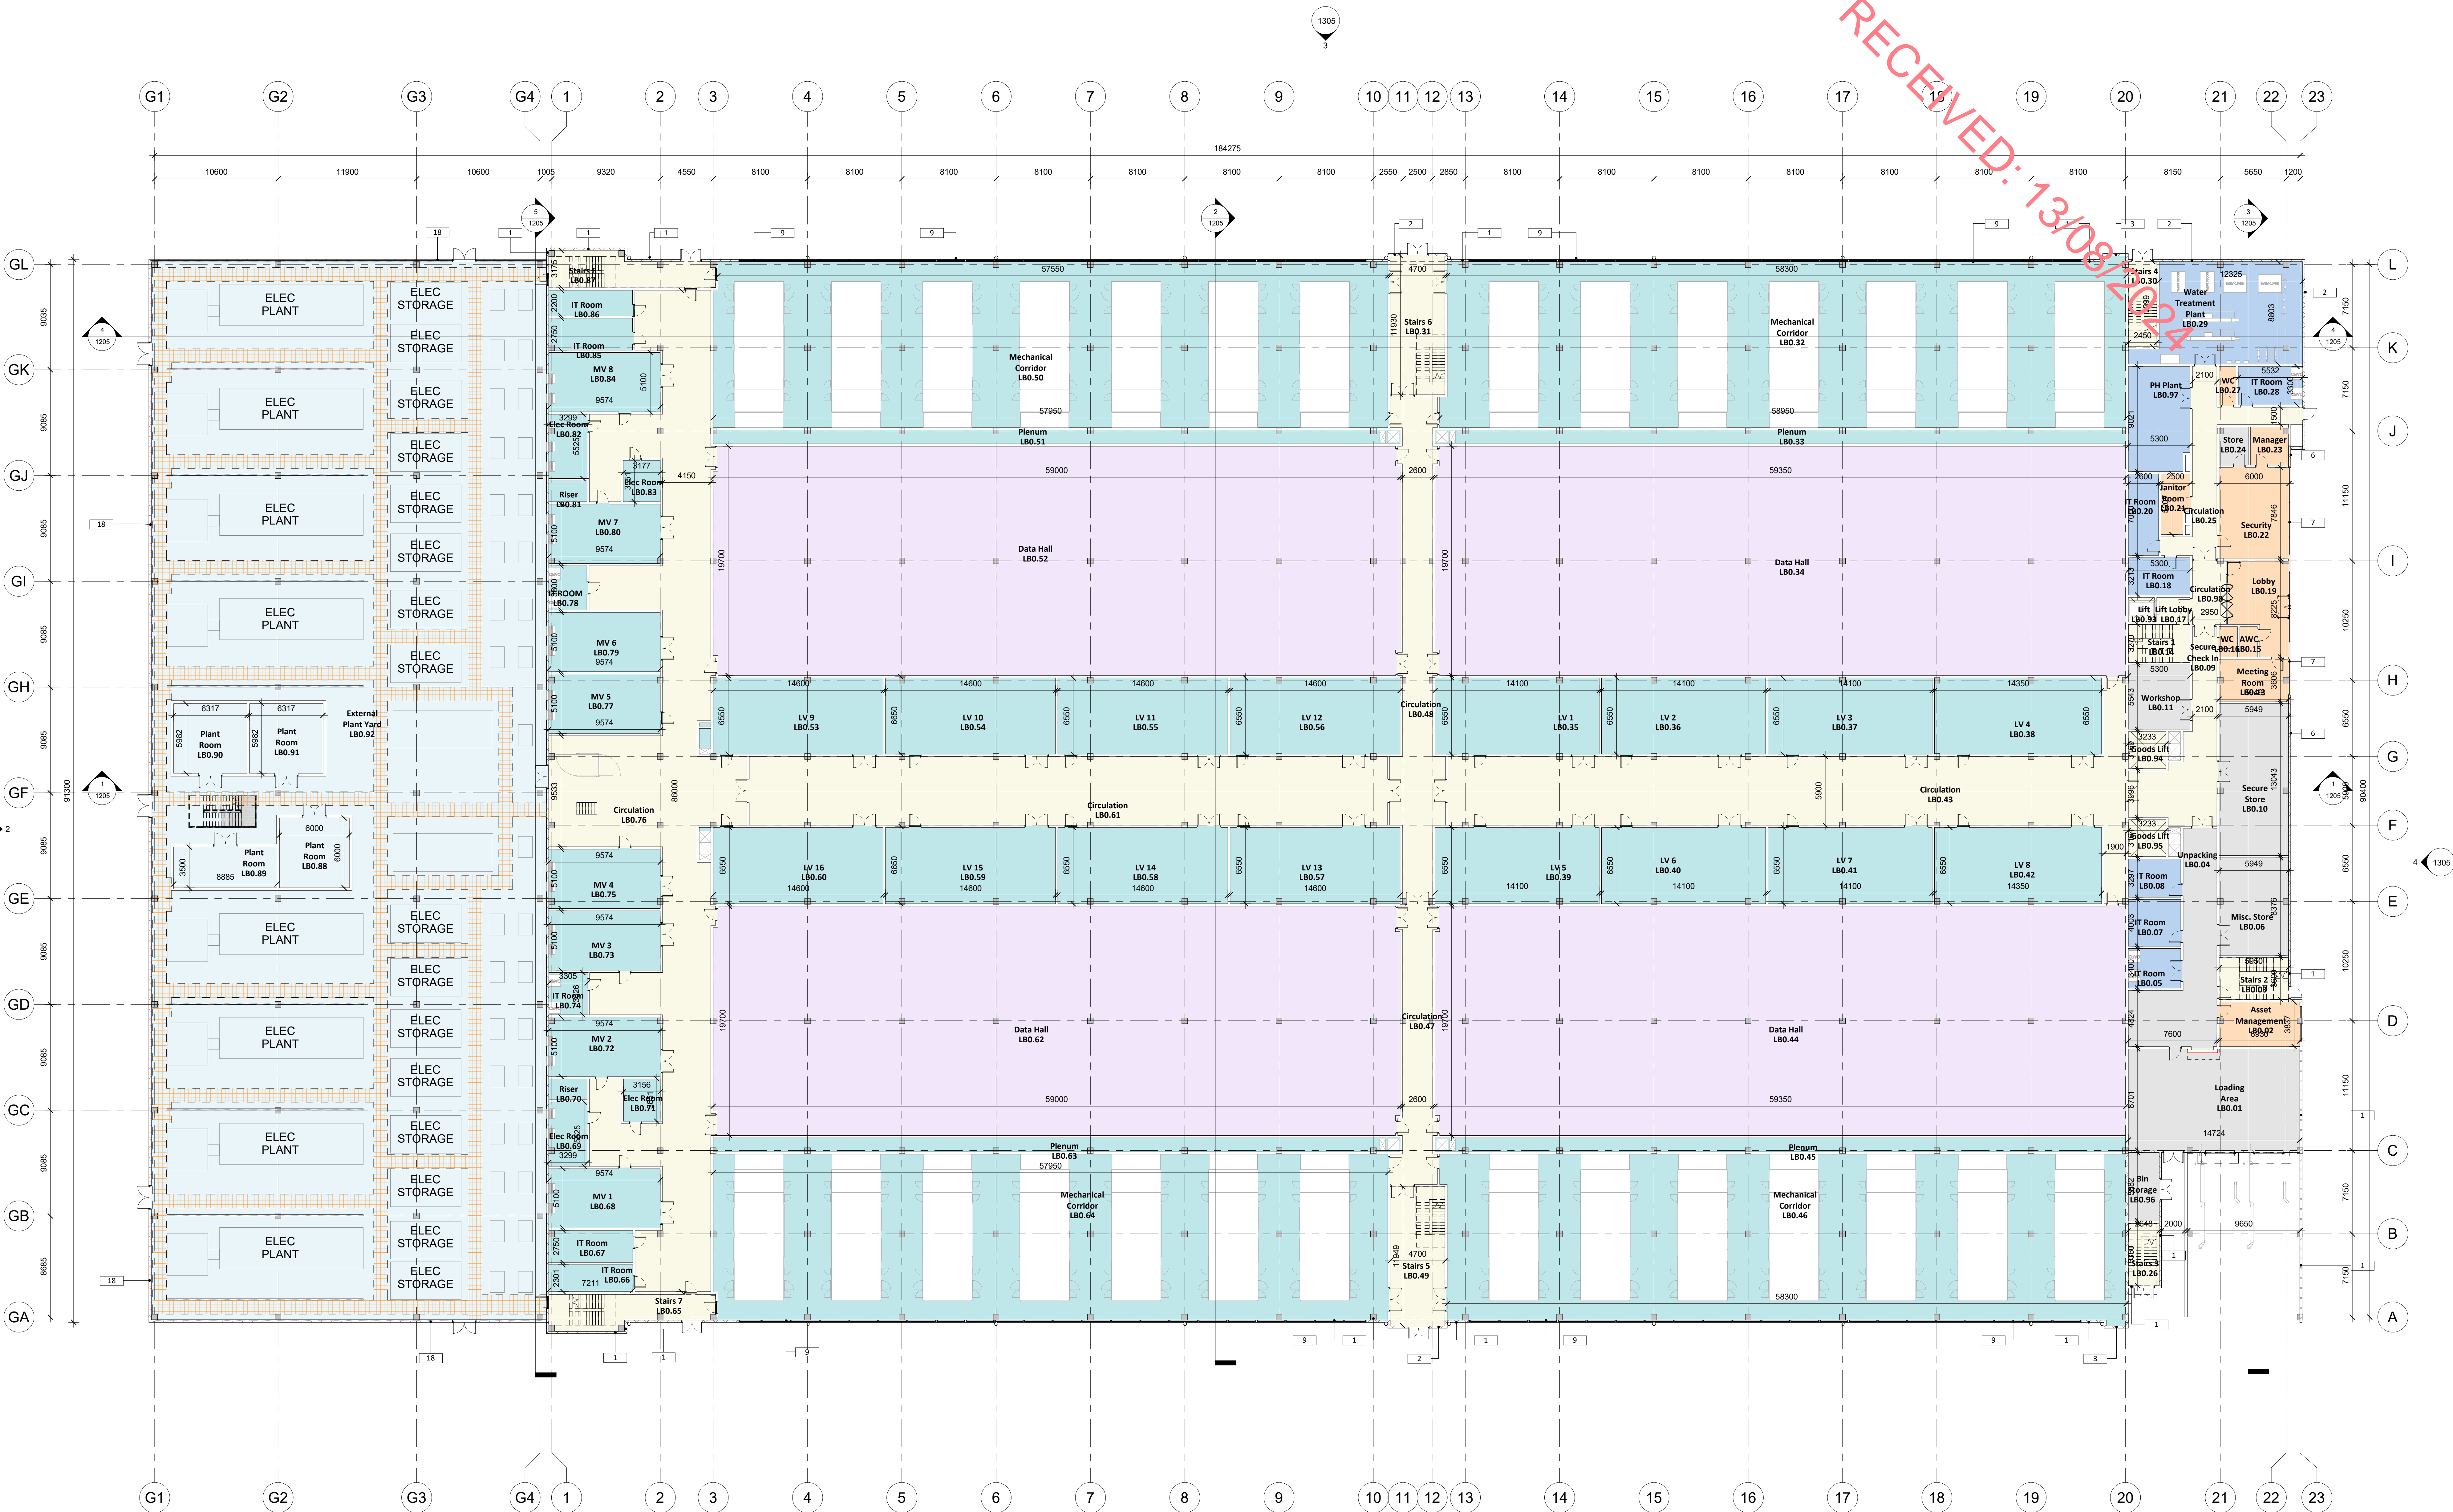

1 A1105_Overall Ground Floor Plan
1 : 200

- AREA LEGEND**
- ADMIN
 - BACK OF HOUSE
 - CIRCULATION
 - DATA HALL
 - EXTERNAL PLANT YARD
 - MECHANICAL/ELECTRICAL
 - STORAGE
 - PLANT YARD WALKWAYS
 - MIN. WIDTH 1500mm
- KEY PLAN**
- TRUE NORTH

Rev.	Date	Description
P04	03/11/2023	PLANNING ISSUE
P03	02/08/2023	PLANNING ISSUE
P02	11/03/2023	PLANNING ISSUE
P01	03/08/2022	SCHEMATIC PLANNING ISSUE

STATUS: **PLANNING**

PROJECT: HERBATA DATA CENTRE CAMPUS

PROJECT ADDRESS: NAAS, CO. KILDARE

DWG TITLE: DATA CENTRE - OVERALL GROUND FLOOR PLAN TYPE C

DWG NO: 22217-RKD-ZZ-00-DR-A-1110

REV. P04 S3 SCALE 1:200

DATE 03/11/2023 DWG RCD CHK KOS

RKD


17 Northumberland Rd
Dublin 15, Ireland
Tel: +353 (0)1 454 1000

BSM

17 Northumberland Rd
Dublin 15, Ireland
Tel: +353 (0)1 454 1000


DONNACHADH O'BRIEN

& ASSOCIATES CONSULTING ENGINEERS

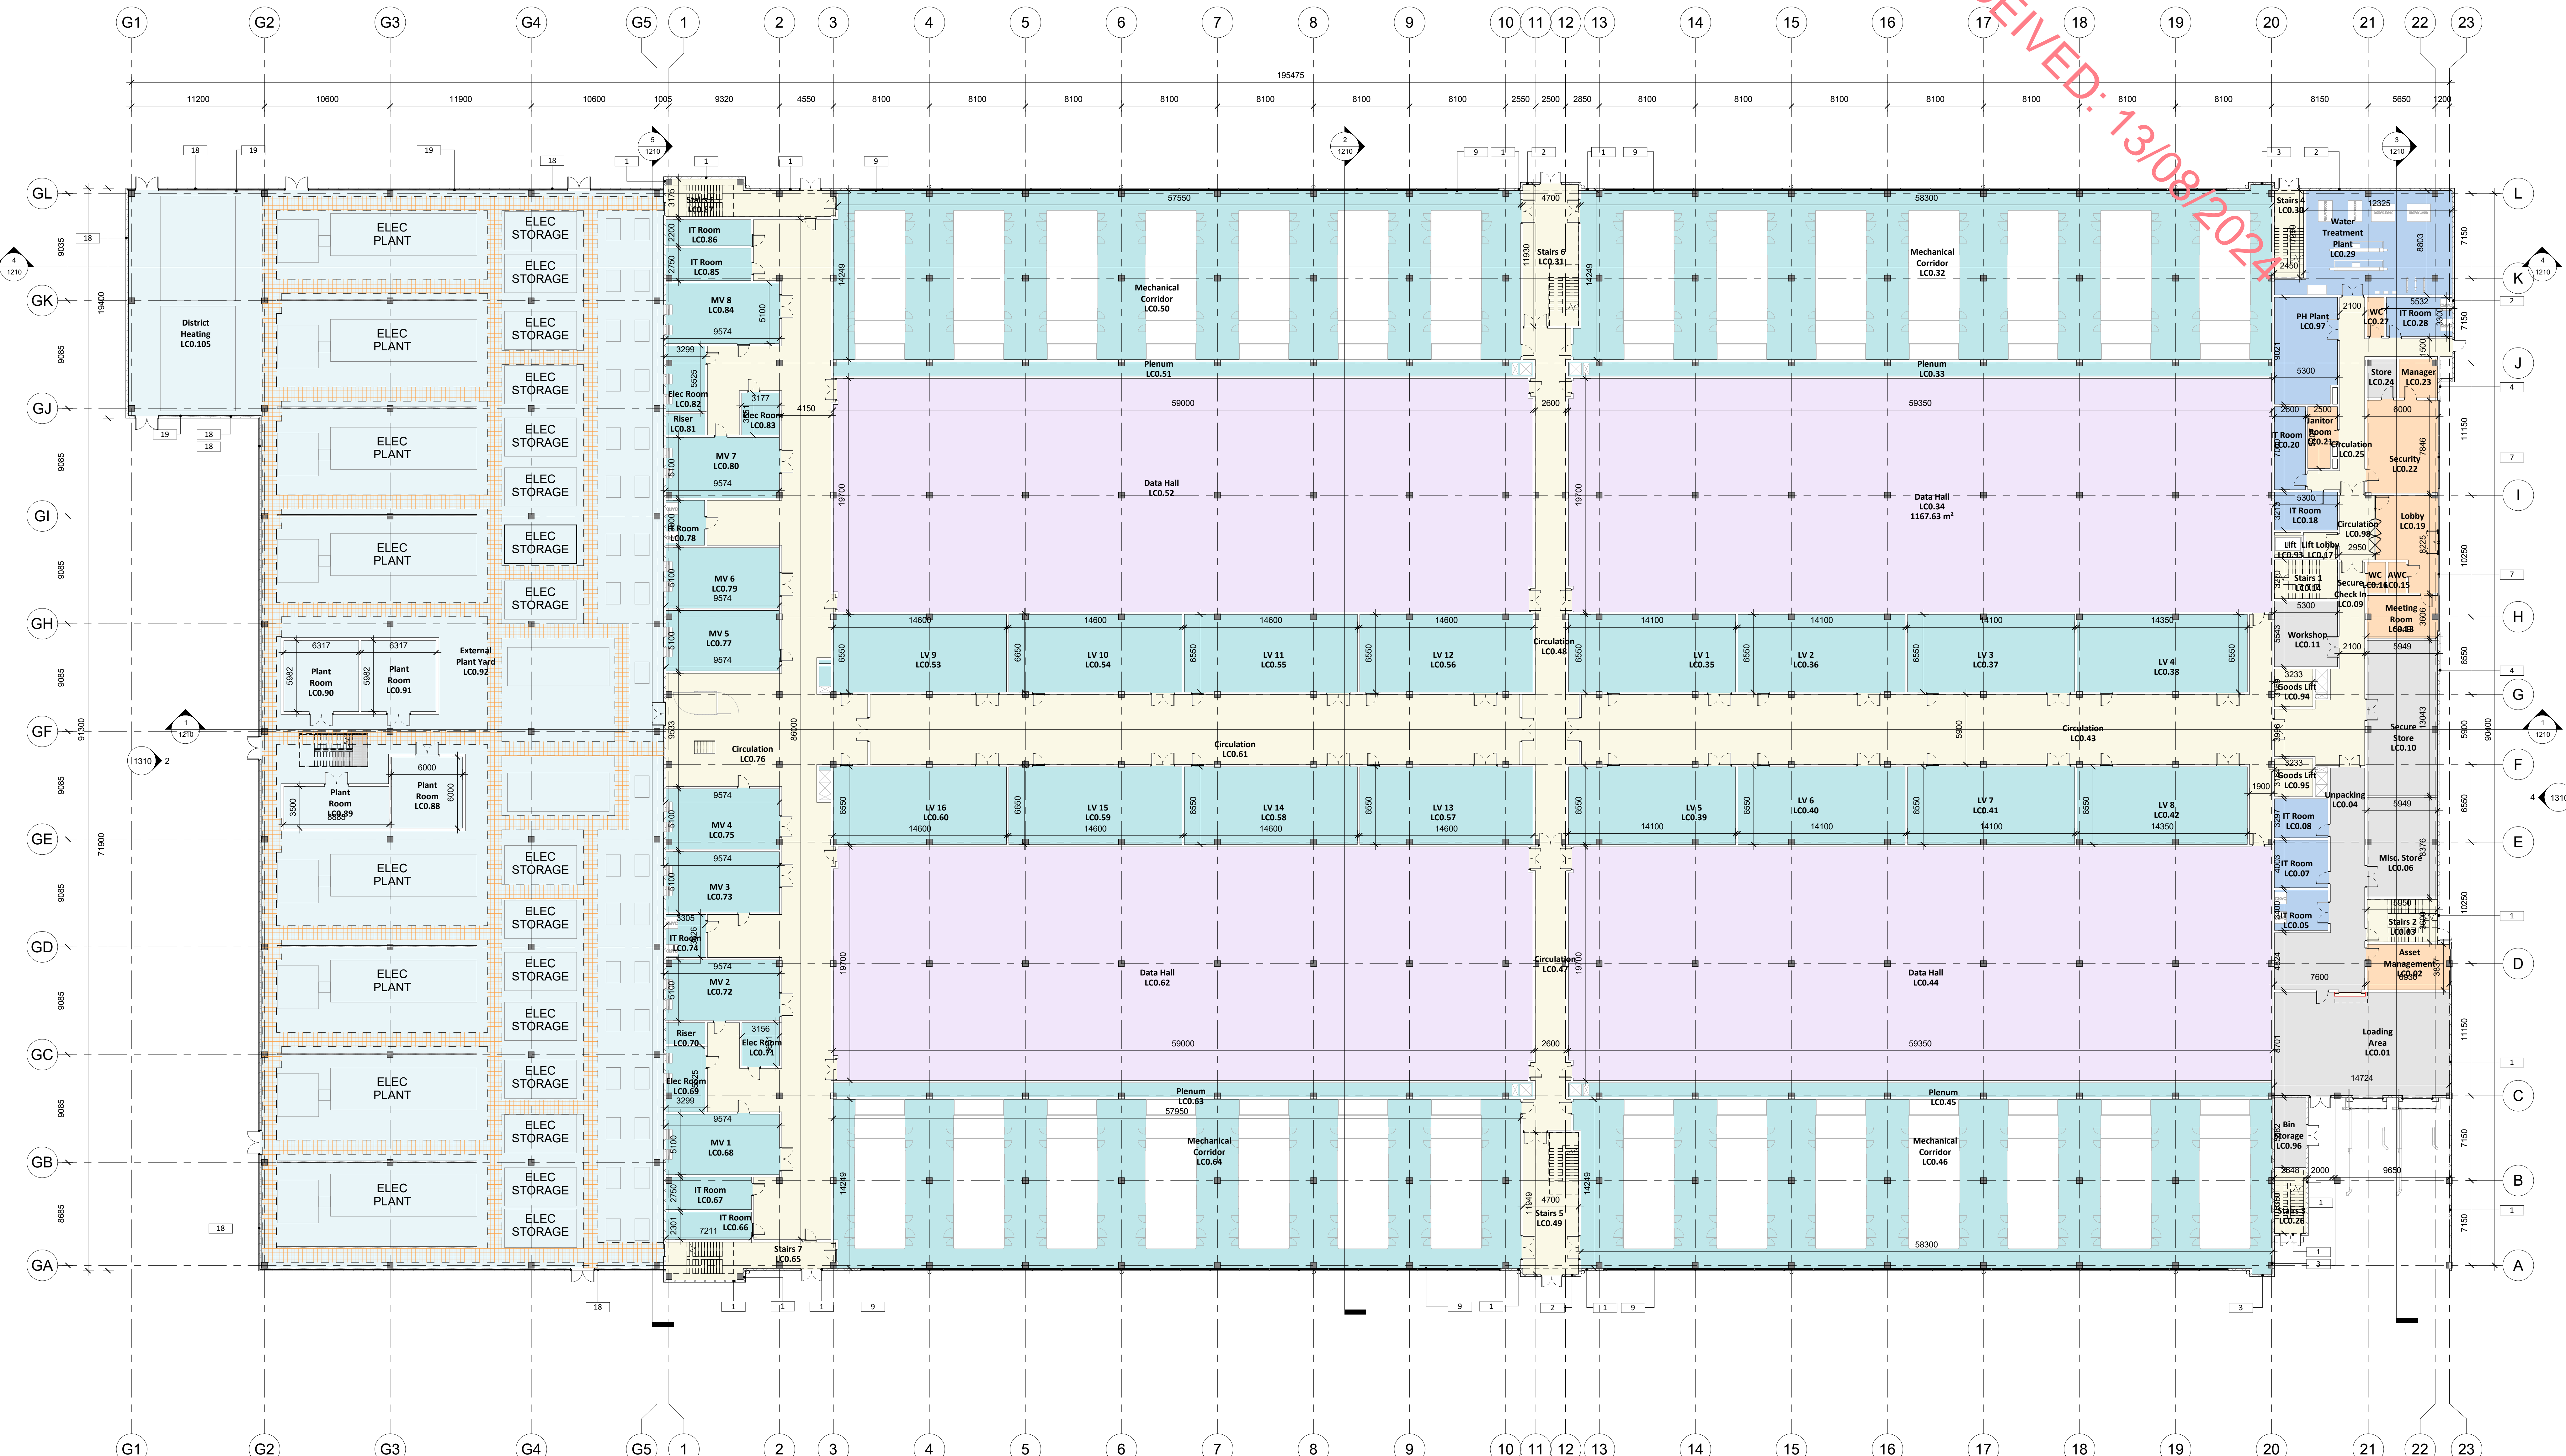






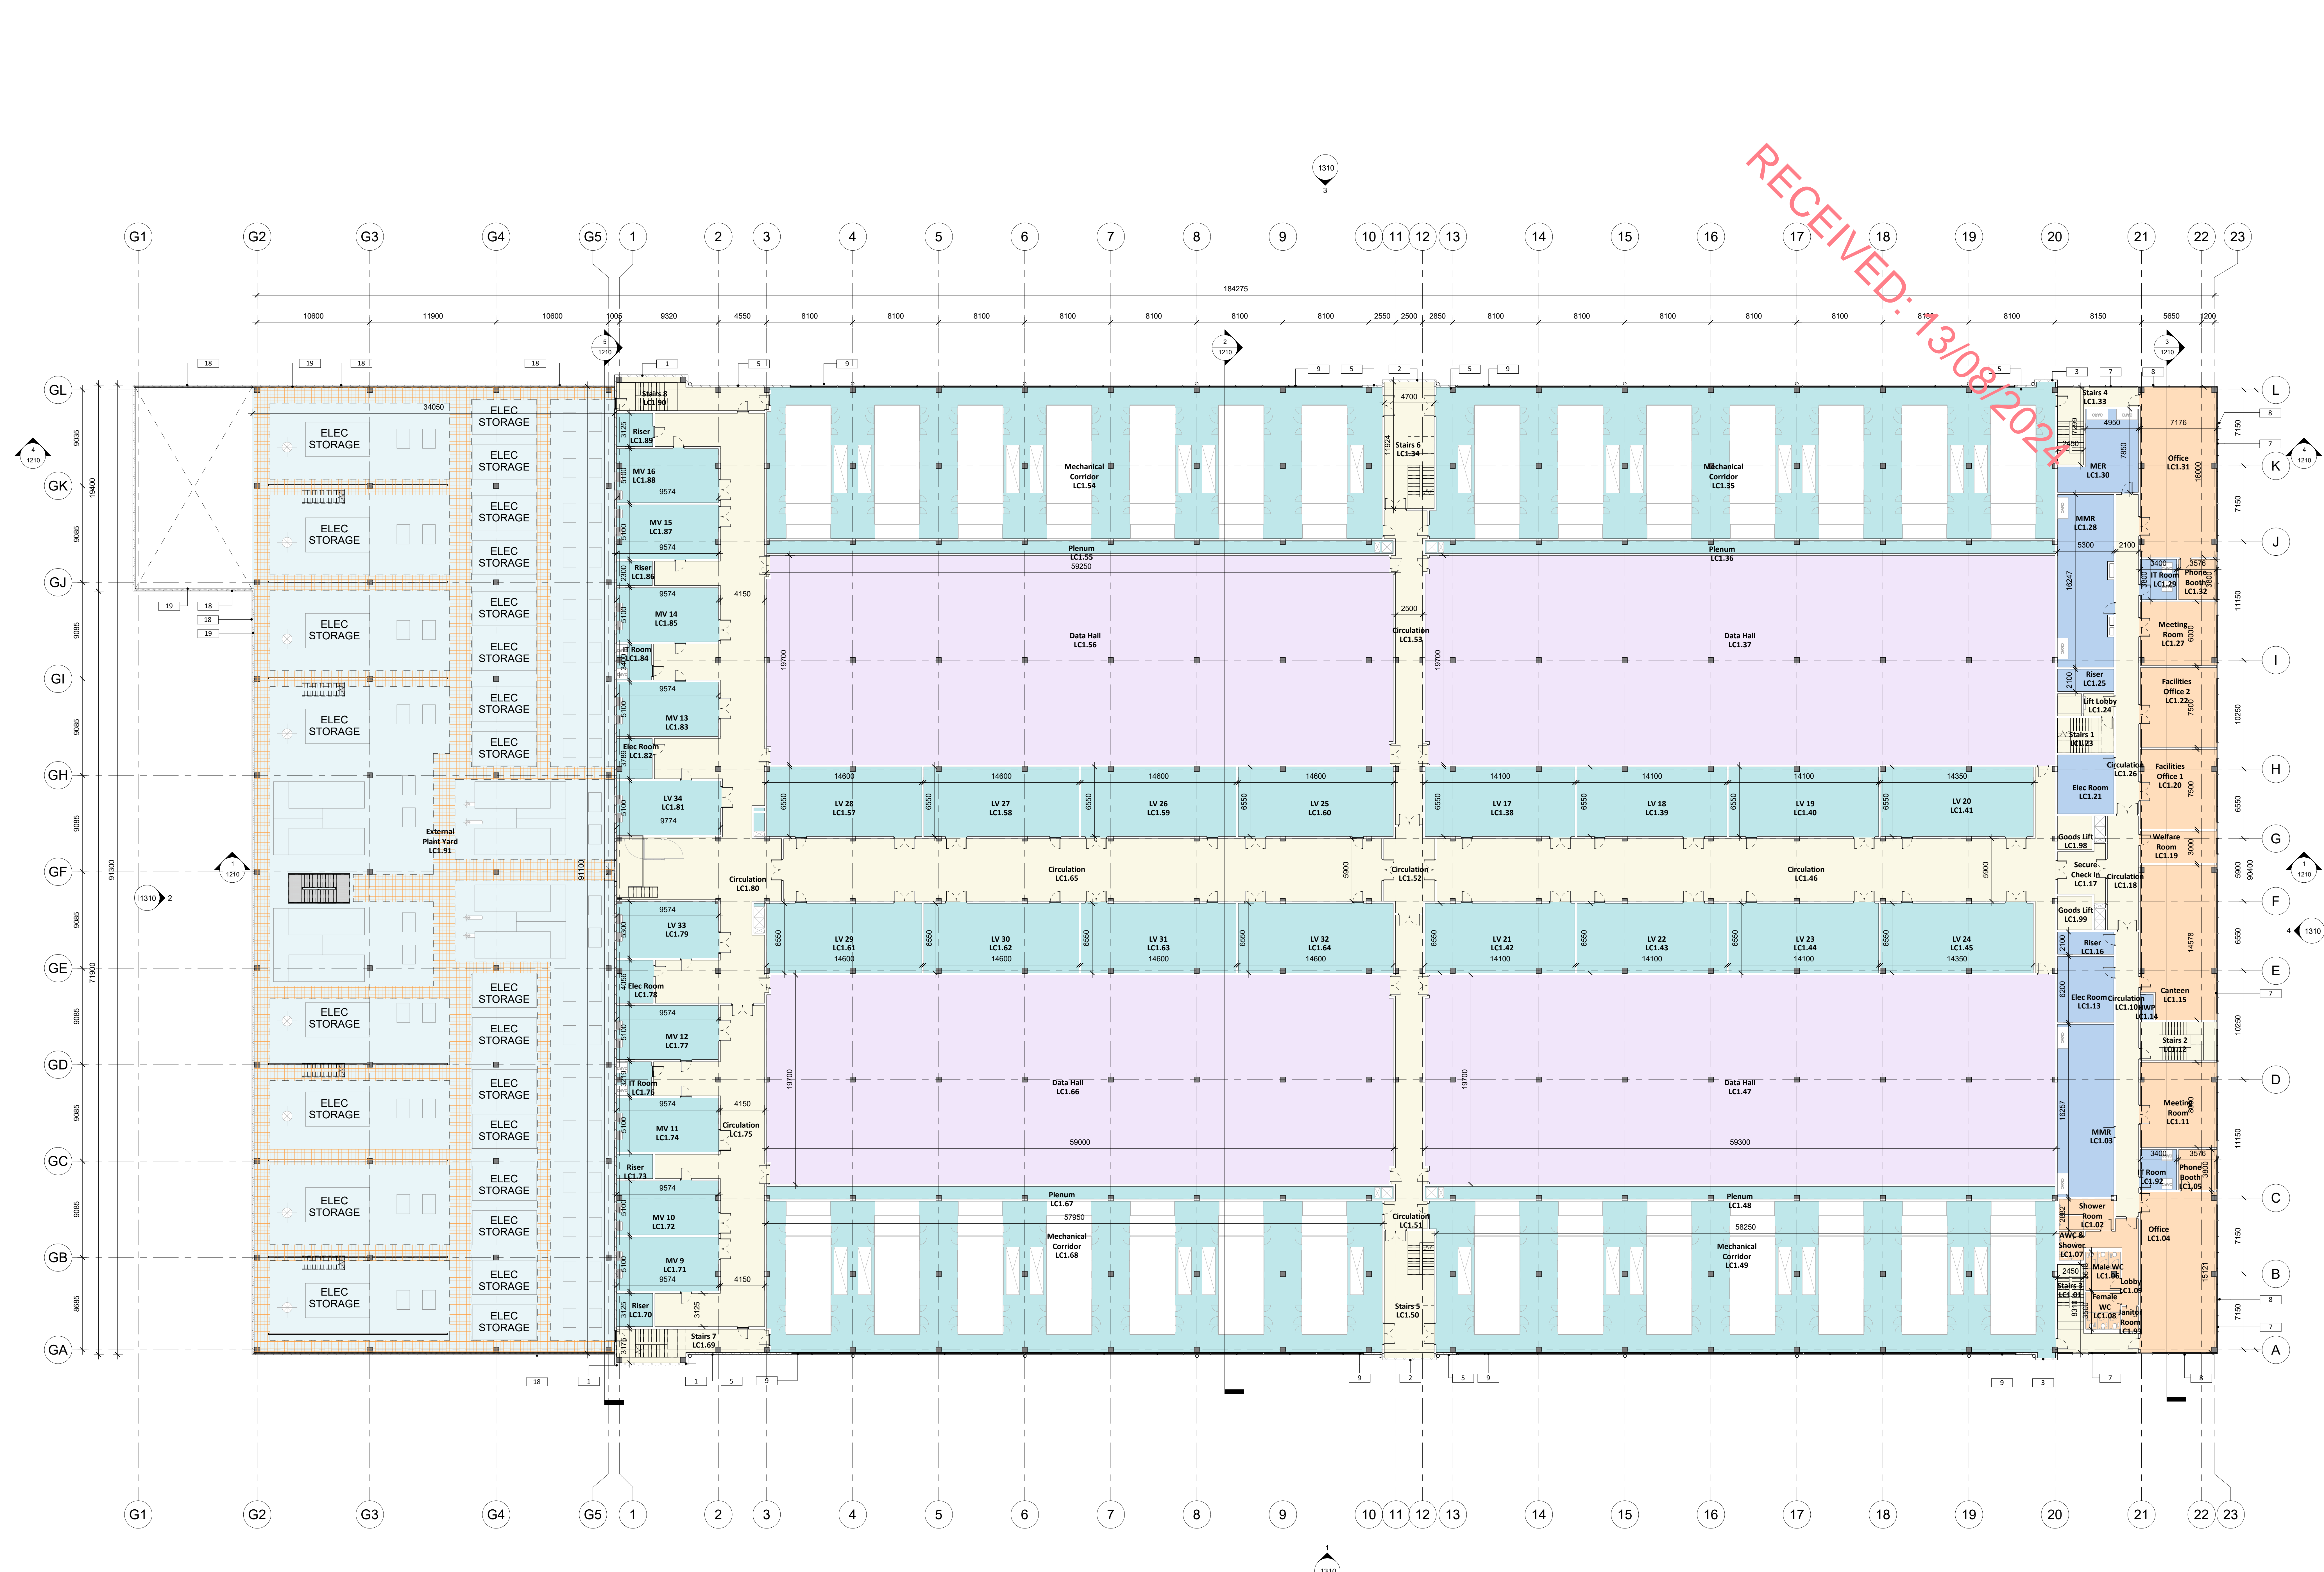

A1111_Overall First Floor Plan
1 : 200


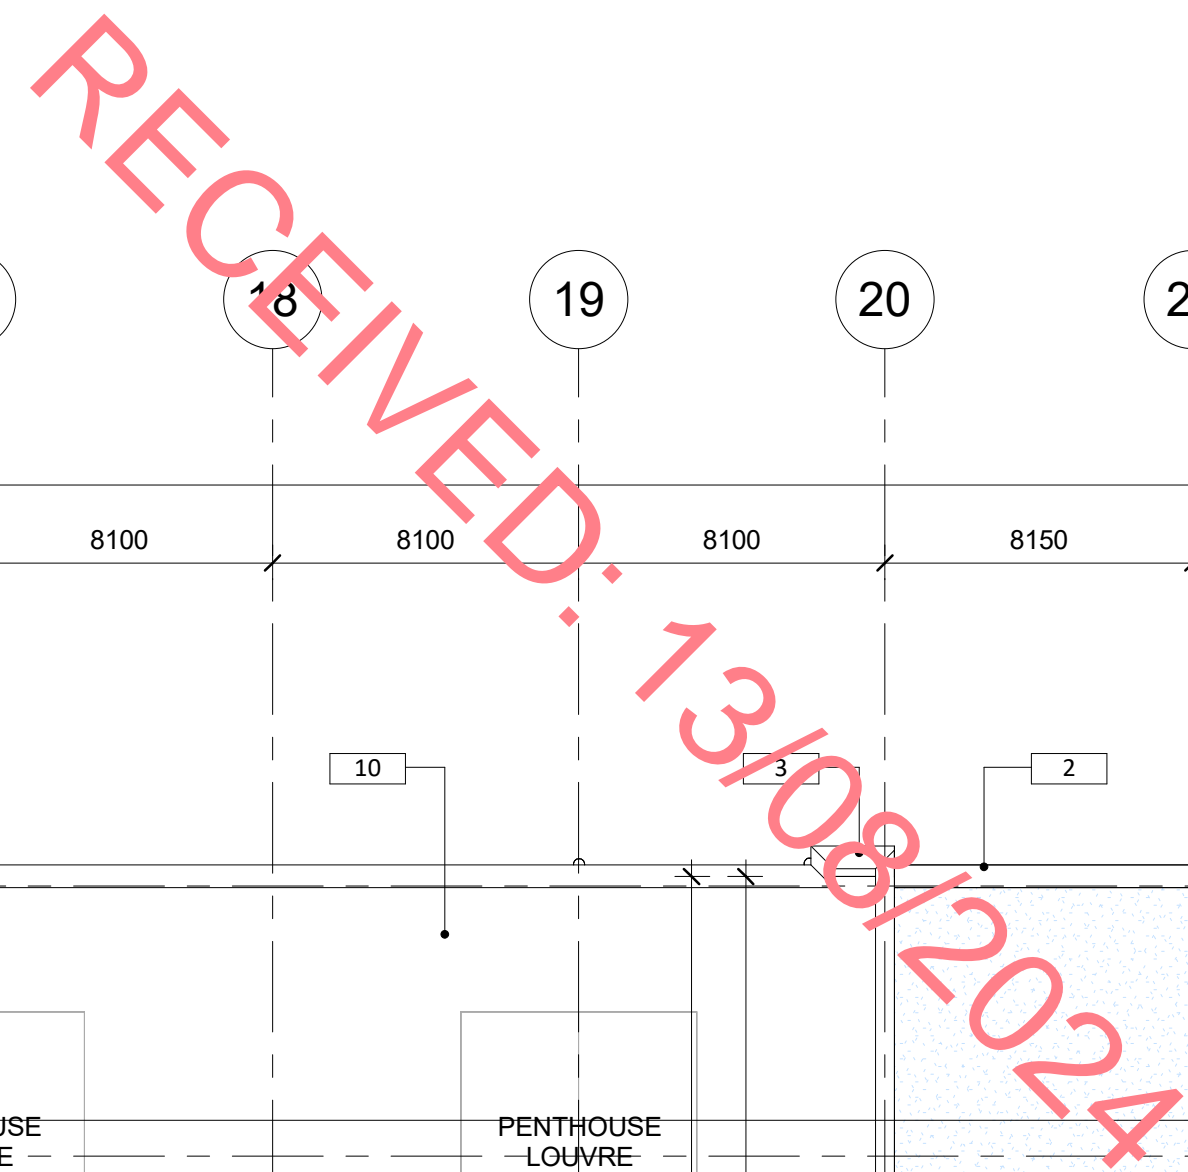


1 **A110**
1 : 200

- Notes:**
1. PROPRIETARY INSULATED METAL CLADDING SYSTEM ON STEEL STRUCTURE (EIROBOND) - FLAT PROFILE PANELS OR OTHER APPROVED TO ADMIN AREA. COLOUR TONE - MEDIUM GREY.
 2. PROPRIETARY INSULATED METAL CLADDING SYSTEM ON STEEL STRUCTURE (EIROBOND) - FLAT PROFILE PANELS OR OTHER APPROVED TO ADMIN AREA. COLOUR TONE - DARK GREY.
 3. PROPRIETARY INSULATED METAL CLADDING SYSTEM ON STEEL STRUCTURE (EIROBOND) - FLAT PROFILE PANELS OR OTHER APPROVED TO ADMIN AREA. COLOUR TONE - OFF-WHITE.
 4. PROPRIETARY INSULATED METAL CLADDING SYSTEM ON STEEL STRUCTURE (EIROBOND) - FLAT PROFILE PANELS OR OTHER APPROVED TO ADMIN AREA. COLOUR TONE - LIGHT GREY.
 5. SELECTED ALUMINIUM RANGECREEN CLADDING SYSTEM ON OTHER APPROVED TO SELECTED COLOUR AROUND ENTRANCE.
 6. SELECTED ALUMINIUM RANGECREEN CLADDING SYSTEM ON OTHER APPROVED TO SELECTED COLOUR.
 7. SELECTED ALUMINIUM RANGECREEN CLADDING SYSTEM ON OTHER APPROVED TO SELECTED COLOUR.
 8. SELECTED ALUMINIUM RANGECREEN CLADDING SYSTEM ON OTHER APPROVED TO SELECTED COLOUR.
 9. SELECTED ALUMINIUM RANGECREEN CLADDING SYSTEM ON OTHER APPROVED TO SELECTED COLOUR.
 10. SELECTED PARALON OR OTHER APPROVED ROOF FINISH LAG TO MANUFACTURERS SPECIFICATION ON STEEL STRUCTURE TO ENGINEERS' FUTURE DETAILS.
 11. SELECTED MEDIUM ROOF FINISH ON BLUE ROOF ATTENUATION LAYER.
 12. ALUMINIUM CANOPY IN SELECTED COLOUR. COLOUR TONE - LIGHT GREY.
 13. 2.4m HIGH PALISADE SECURITY FENCE AROUND PLANT AREAS, DATA BUILDINGS AND ASSOCIATED STRUCTURES.
 14. 1.2m HIGH AGRICULTURAL TIMBER POST AND WIRE MESH FENCING TO WESTERN BOUNDARY FENCE.
 15. 1.2m HIGH TIMBER POST AND RAIL FENCE TO SURROUND FENCE.
 16. 2.4m HIGH PALISADE SECURITY FENCE AROUND ENTIRE SITE.
 17. SELECTED BEDUM ROOF FINISH.
 18. EXTERNAL METAL LOUVRE TO ACOUSTIC SCREEN WALL.
 19. ACOUSTIC PANEL.

AREA LEGEND

ADMIN	ADMIN
BACK OF HOUSE	BACK OF HOUSE
CIRCULATION	CIRCULATION
DATA HALL	DATA HALL
EXTERNAL PLANT YARD	EXTERNAL PLANT YARD
MECHANICAL/ELECTRICAL	MECHANICAL/ELECTRICAL
STORAGE	STORAGE

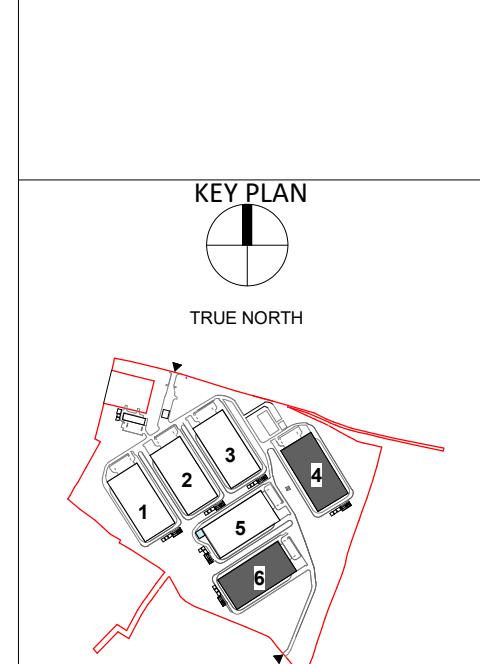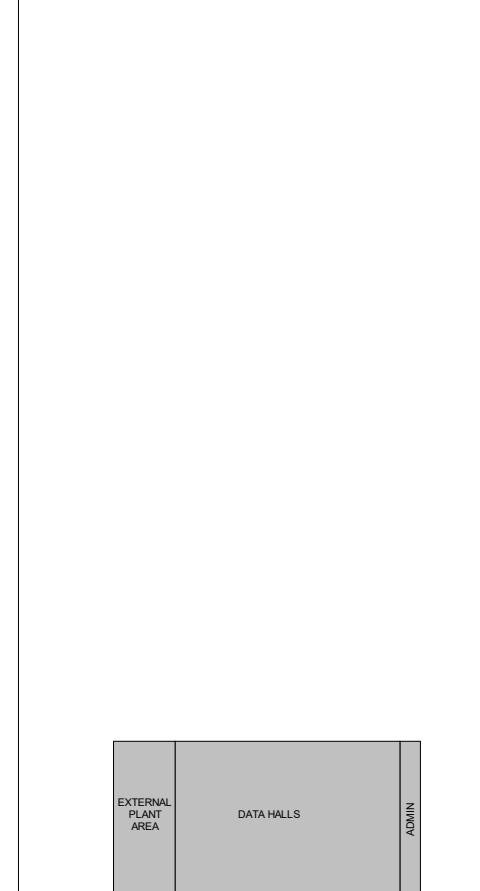

NO.	DATE	DESCRIPTION
P04	03/11/2023	PLANNING ISSUE
P03	03/08/2023	PLANNING ISSUE
P02	11/03/2023	PLANNING ISSUE
P01	03/08/2023	PLANNING ISSUE
Rev.	Date	Description

STATUS
PLANNING

PROJECT
HERBATA DATA CENTRE
CAMPUS

PROJECT ADDRESS
NAAS, CO. KILDARE

DWG TITLE
DATA CENTRE - OVERALL
ROOF PLAN
TYPE B

DWG NO.
22217-RKD-ZF-RF-DR-A-1107


REV.
P04 S3 SCALE 1:200

DATE
03/11/2023 [DWG] RCD [CHK] KOS

RKD
RCD Architects
17 Ardara Road
Dublin, D15 X111, Ireland
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17 Ardara Road
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Tel: +353 (0)1 850 1000

DONNACHADH O'BRIEN
& ASSOCIATES CONSULTING ENGINEERS


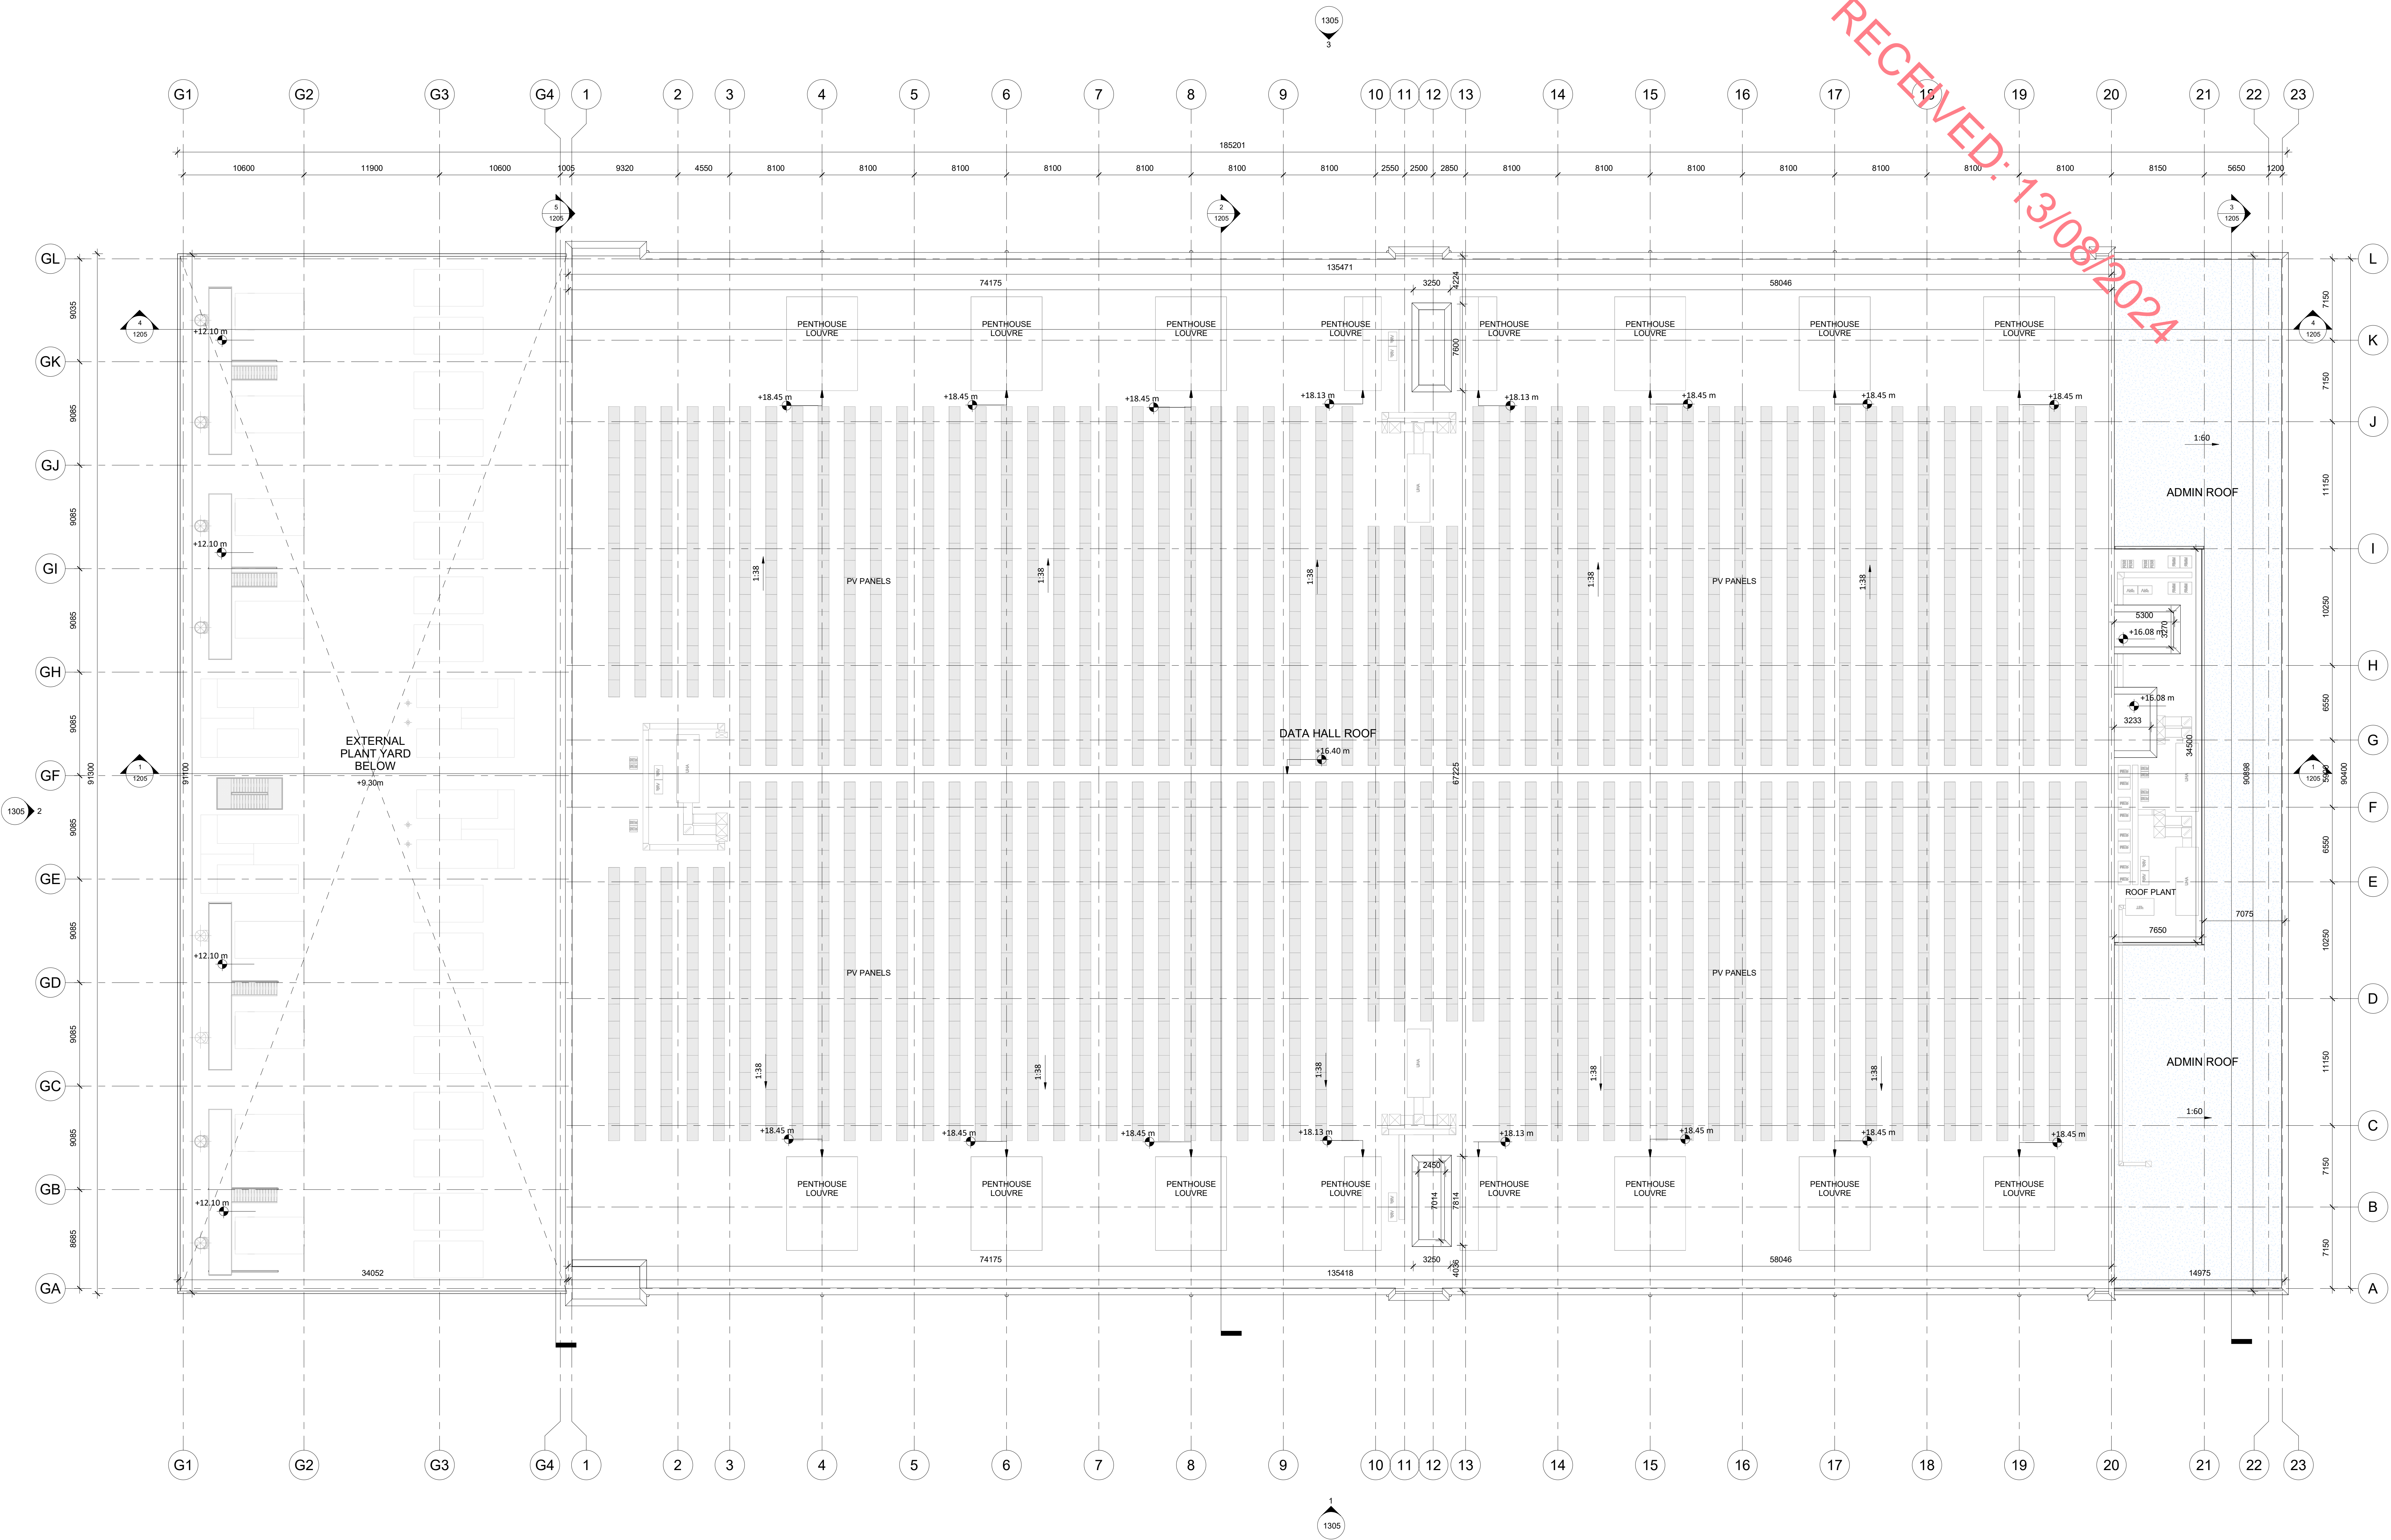


1 A1107_Overall Roof Plan
1 : 200

- Notes:**
1. PROPRIETARY INSULATED METAL CLADDING SYSTEM ON STEEL STRUCTURE (EUROBOND - FLAT PROFILE PANELS OR OTHER APPROVED) TO ADMIN AREA. COLOUR TONE - MEDIUM DARK GREY.
 2. PROPRIETARY INSULATED METAL CLADDING SYSTEM ON STEEL STRUCTURE (EUROBOND - FLAT PROFILE PANELS OR OTHER APPROVED) TO ADMIN AREA. COLOUR TONE - MEDIUM DARK GREY.
 3. PROPRIETARY INSULATED METAL CLADDING SYSTEM ON STEEL STRUCTURE (EUROBOND - FLAT PROFILE PANELS OR OTHER APPROVED) TO ADMIN AREA. COLOUR TONE - MEDIUM DARK GREY.
 4. PROPRIETARY INSULATED METAL CLADDING SYSTEM ON STEEL STRUCTURE (EUROBOND - FLAT PROFILE PANELS OR OTHER APPROVED) TO ADMIN AREA. COLOUR TONE - OFF-WHITE.
 5. PROPRIETARY INSULATED METAL CLADDING SYSTEM ON STEEL STRUCTURE (EUROBOND - FLAT PROFILE PANELS OR OTHER APPROVED) TO ADMIN AREA. COLOUR TONE - LIGHT GREY.
 6. SELECTED ALUMINUM RAINSCREEN CLADDING SYSTEM OR OTHER APPROVED IN SELECTED COLOUR AROUND ENTRANCE.
 7. SELECTED GLAZED CURTAIN WALL SYSTEM WITH GLAZED AND SPANREL PANELS IN SELECTED COLOUR.
 8. SELECTED VERTICAL ALUMINUM FINS IN SELECTED COLOUR.
 9. SELECTED HORIZONTAL MICRO LOUVRES SET INTO PANELS TO PLANT ROOM FACADE.
 10. SELECTED PARALON OR OTHER APPROVED ROOF FINISH LAG TO MANUFACTURERS SPECIFICATION ON STEEL STRUCTURE TO ENGINEERS FUTURE DETAILS.
 11. SELECTED SEDUM ROOF FINISH ON BLUE ROOF ATTENUATION LAYER.
 12. ALUMINUM CANOPY IN SELECTED COLOUR. COLOUR TONE - LIGHT GREY.
 13. 2.4m HIGH PALLIAD SECURITY FENCE AROUND PLANT AREAS, DATA BUILDINGS AND ASSOCIATED STRUCTURE.
 14. 1.3m HIGH AGRICULTURAL TIMBER POST AND WIRE MESH FENCING TO WESTERN BOUNDARY HEDGE.
 15. 1.2m HIGH TIMBER POST AND RAIL FENCE TO SURROUND FENCES.
 16. 2.4m HIGH PALLIAD SECURITY FENCE AROUND ENTIRE SITE.
 17. SELECTED SEDUM ROOF FINISH.
 18. EXTERNAL METAL LOUVRE TO ACOUSTIC SCREEN WALL.
 19. ACOUSTIC PANEL.

AREA LEGEND

ADMIN
BACK OF HOUSE
CIRCULATION
DATA HALL
EXTERNAL PLANT YARD
MECHANICAL/ELECTRICAL
STORAGE

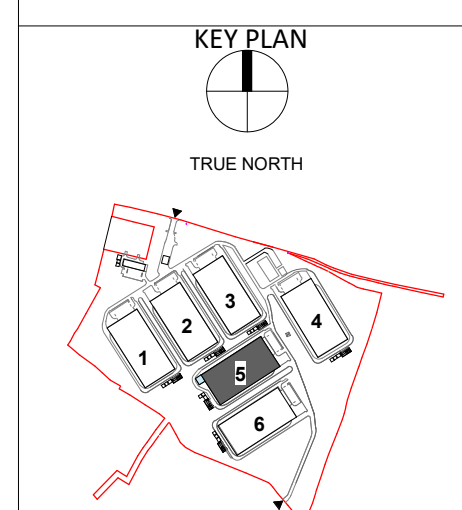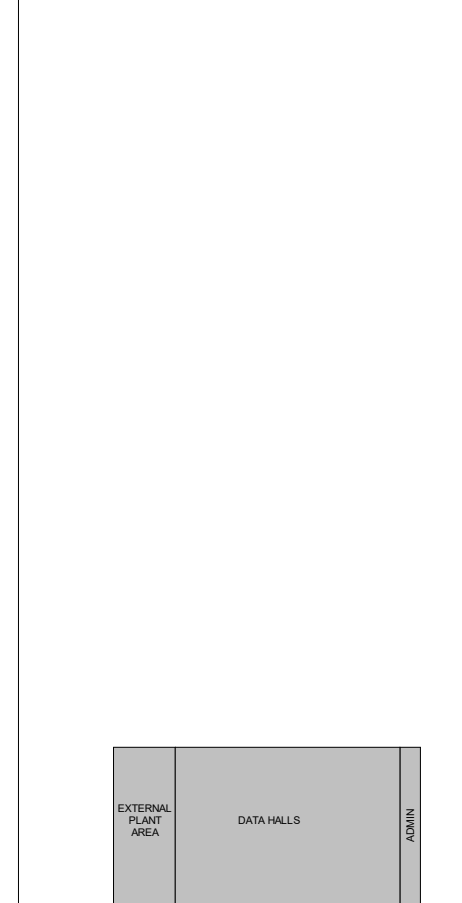

Rev.	Date	Description
P04	03/11/2023	PLANNING ISSUE
P03	03/08/2023	PLANNING ISSUE
P02	11/03/2023	PLANNING ISSUE
P01	03/08/2023	SKETCH PLANNING ISSUE

STATUS: **PLANNING**

PROJECT: HERBATA DATA CENTRE CAMPUS


PROJECT ADDRESS: NAAS, CO. KILDARE

DWG TITLE: DATA CENTRE - OVERALL ROOF PLAN TYPE C


DWG NO:	22217-RKD-ZZ-RF-DR-A-1112
REV:	SUBMITALITY PROJECT NO: 22217
P04	S3 SCALE: 1:200
DATE:	03/11/2023 DWG RCD CHK KOS



DONNACHADH O'BRIEN & ASSOCIATES CONSULTING ENGINEERS

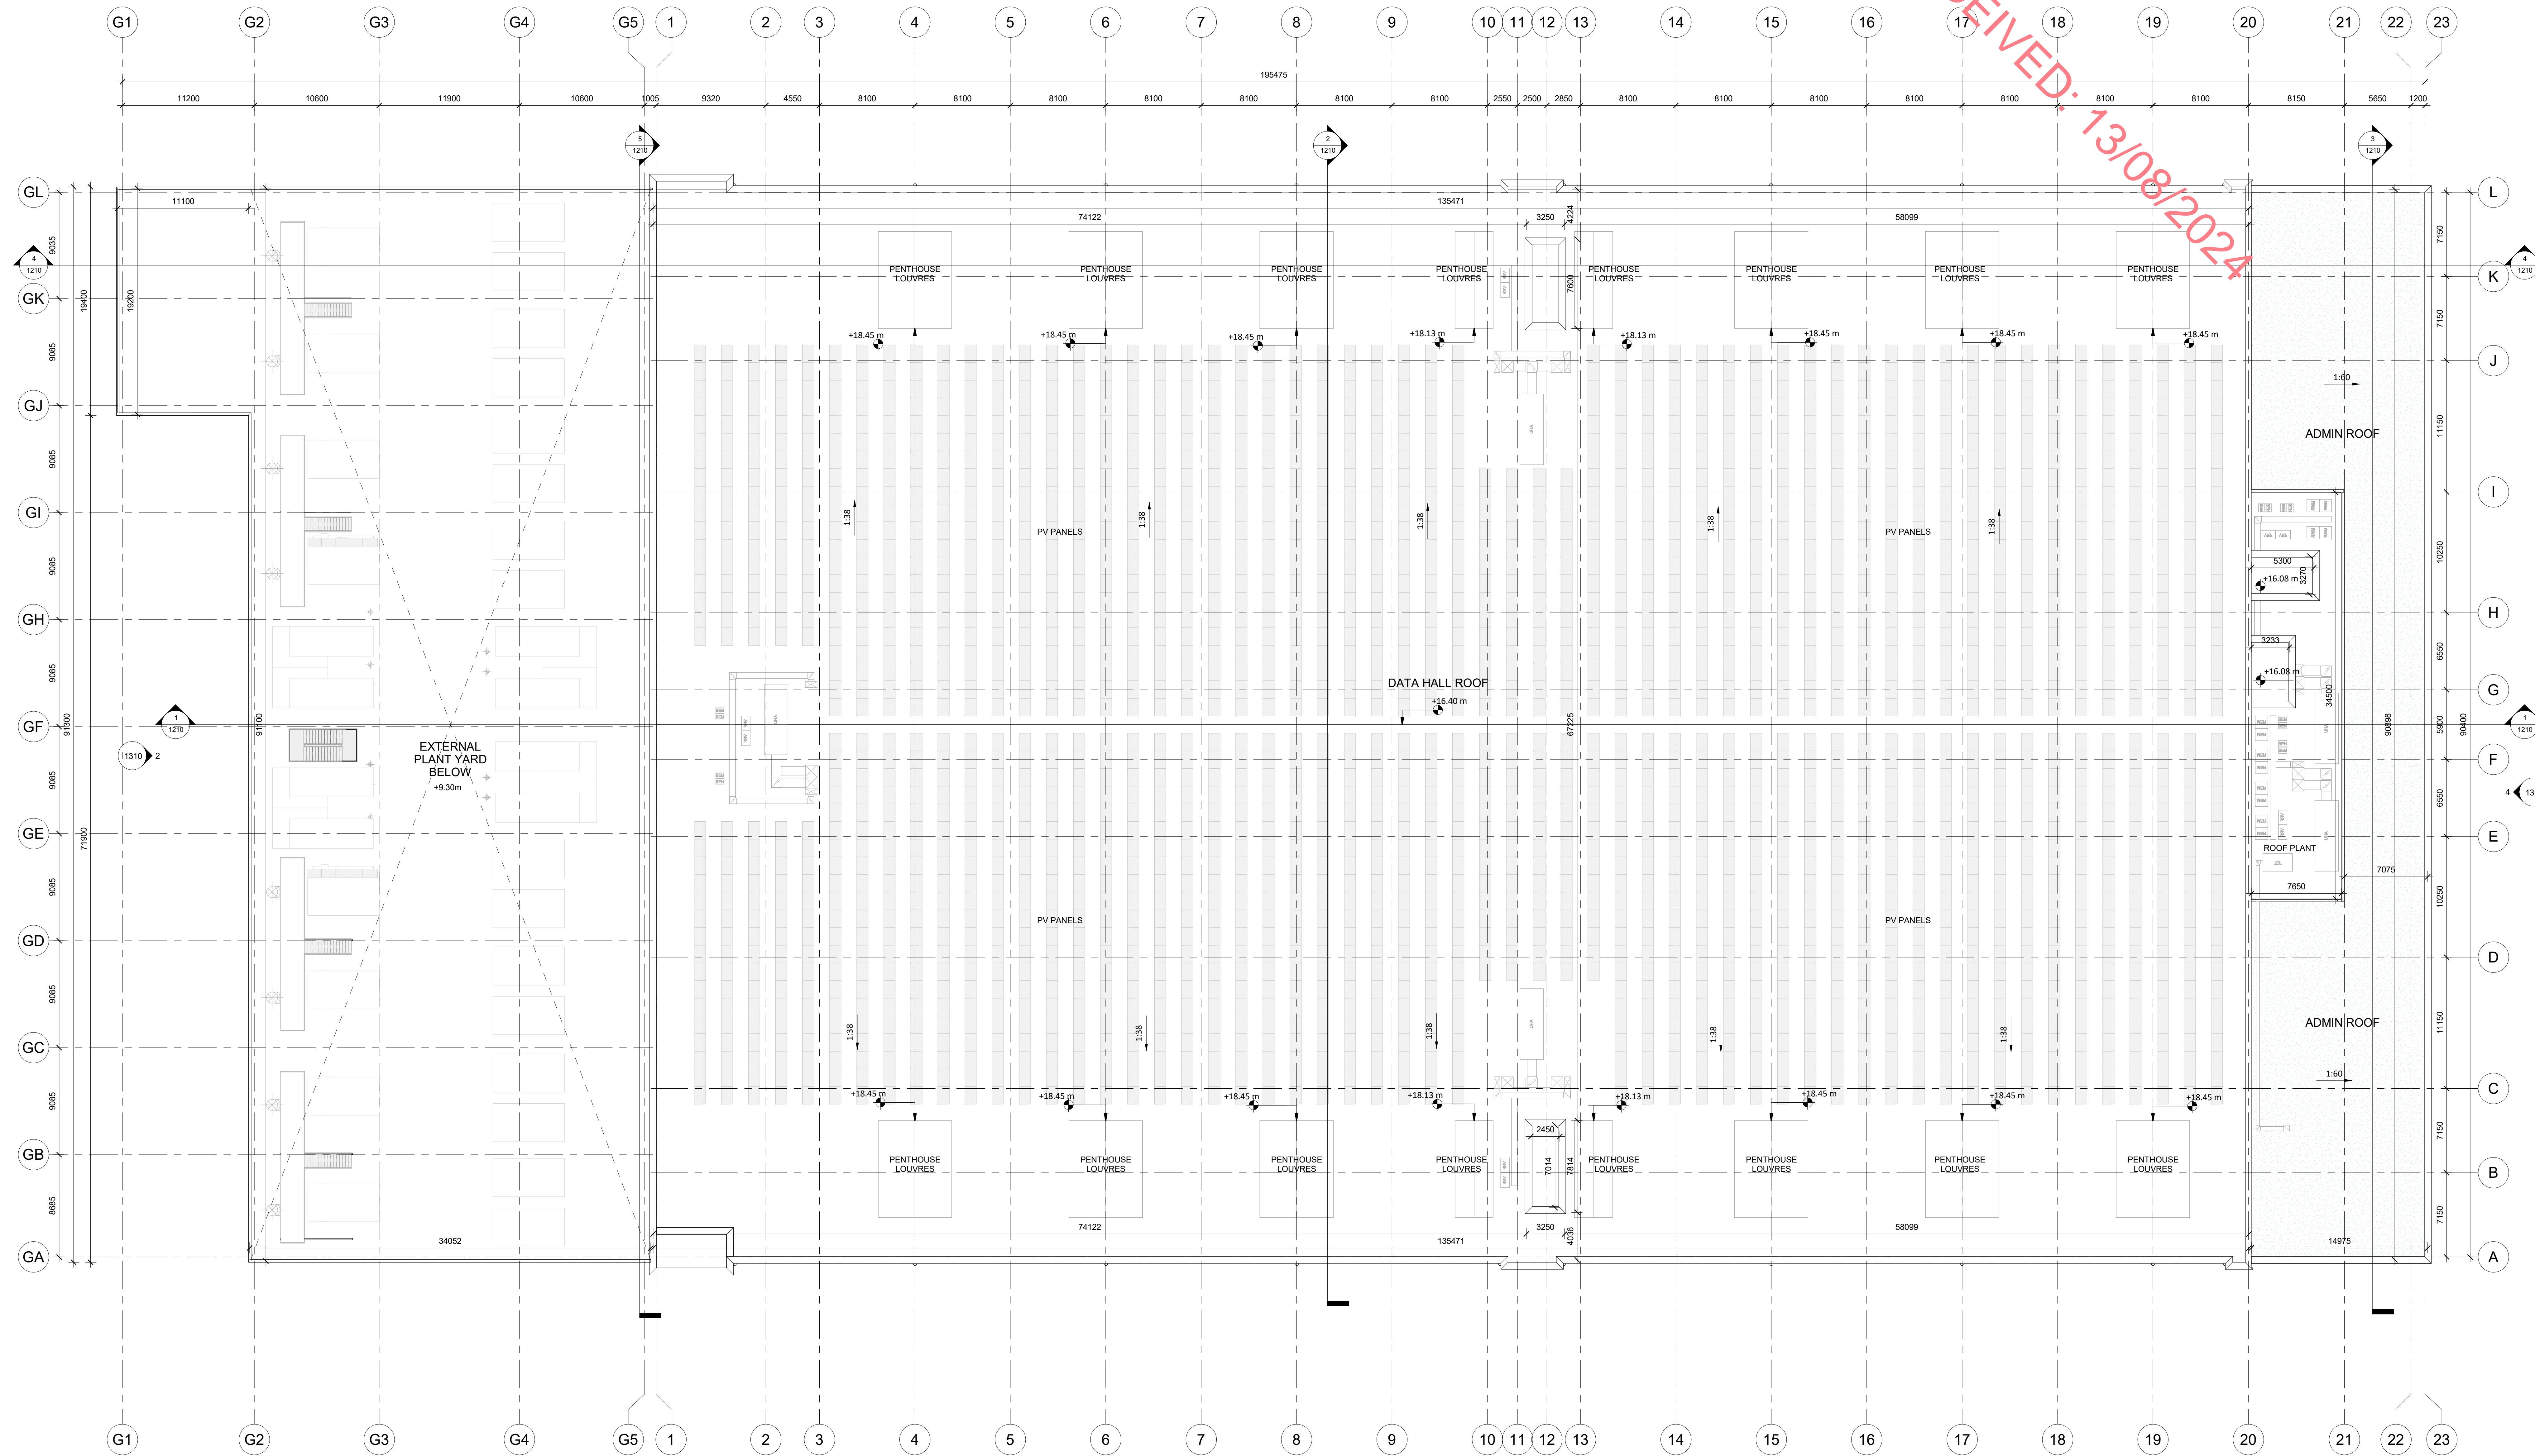

A1112_Overall Roof Plan
1 : 200

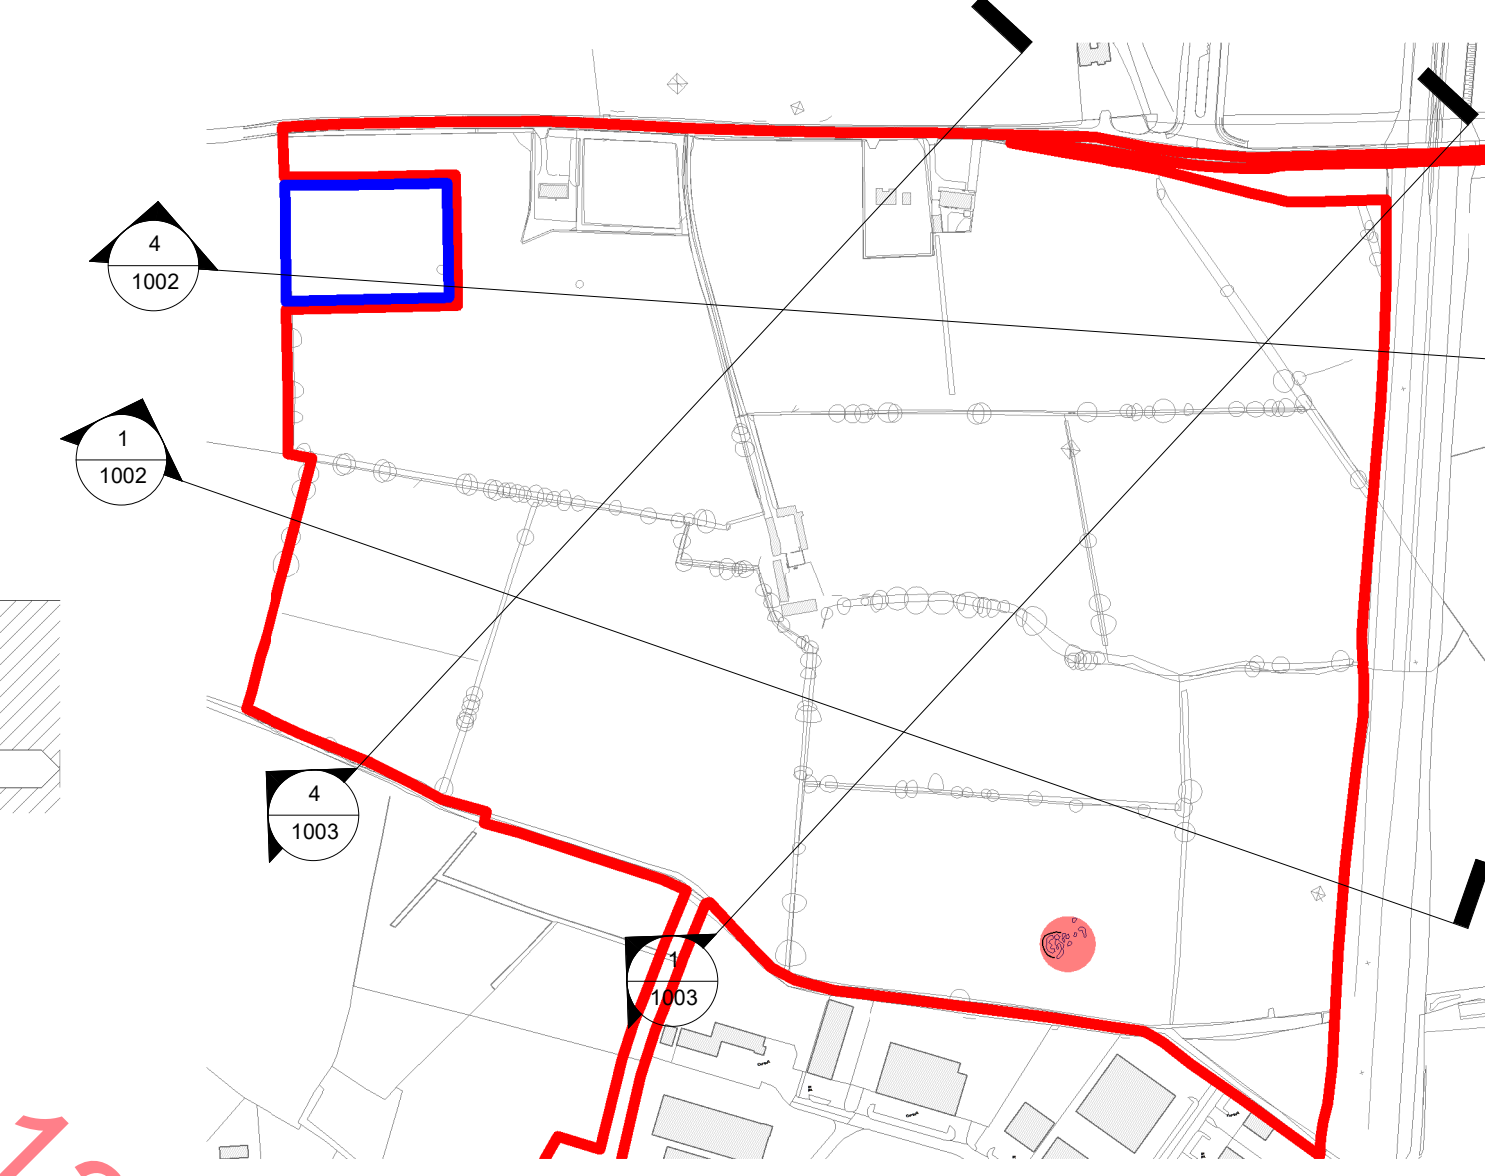

EXISTING HOUSE TO BE DEMOLISHED

6372

5000

APPLICATION SITE

PLANNING APPLICATION BOUNDARY

MOTORWAY


The site plan shows the application site, which is a large rectangular area. To the north of the application site, there are two existing houses marked for demolition. The house on the left is labeled 'EXISTING HOUSE TO BE DEMOLISHED' and has a height of 4.9m. The house on the right is also labeled 'EXISTING HOUSE TO BE DEMOLISHED' and has a height of 6.0m. A dashed line indicates the 'PLANNING APPLICATION BOUNDARY' on the left side of the site. The area between the application site and the existing houses is labeled 'EXISTING HOUSE'.

A cross-section diagram of the application site. The ground surface is shown with a line of trees and shrubs. Below the ground, the area is labeled 'APPLICATION SITE'. On the left, there are three existing houses, each labeled 'EXISTING HOUSE TO BE DEMOLISHED'. The houses are shown in red. The first house has a height of 6806, the second has a height of 4616, and the third has a height of 4809. A horizontal line below the houses is labeled 'EXISTING HOUSES'. To the right of the houses, there is a vertical dashed line labeled 'PLANNING APPLICATION BOUNDARY'. Further to the right, there is a hatched area labeled 'MOTORWAY'.

All dimensions to be checked on site. Figured dimensions take preference over scaled dimensions. Any errors or discrepancies to be reported to the Architects. This drawing may not be edited or modified by the recipient.

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RKD Architects' Quality Management Systems are certified to ISO 9001:2015.

[illegible]

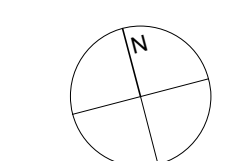P06	03/11/2023	PLANNING ISSUE
P05	02/08/2023	PLANNING ISSUE
P04	11/07/2023	PLANNING ISSUE
P03	02/06/2023	DRAFT PLANNING ISSUE
P02	28/04/2023	STAGE 2 ISSUE
P01	10/03/2023	DRAFT ISSUE
Rev.	Date	Description

STATUS	PLANNING
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PROJECT	HERBATA DATA CENTRE CAMPUS
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PROJECT ADDRESS	NAAS, CO. KILDARE
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DWG TITLE	EXISTING SITE SECTIONS - SHEET 1
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DWG NO.
22217-RKD-ZZ-ZZ-DR-A-1002

REV.	SUITABILITY	PROJECT NO.	22217
P06	S3	SCALE	VARIES

DATE	03/11/2023	DRN	RCD	CHK	KOS
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RKD

59 Northumberland Rd
Ballsbridge, Dublin 4
D04 WP99, Ireland


כ"א	ב"מ
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FDR | **BSM**

Est. 1968

<p> <input type="checkbox"/> Yes (I agree to the terms) <input type="checkbox"/> No (I do not agree to the terms) </p>	<p> <input type="checkbox"/> Yes (I agree to the terms) <input type="checkbox"/> No (I do not agree to the terms) </p>
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.....
& ASSOCIATES CONSULTING ENGINEERS



RECEIVED: 13/08/2024

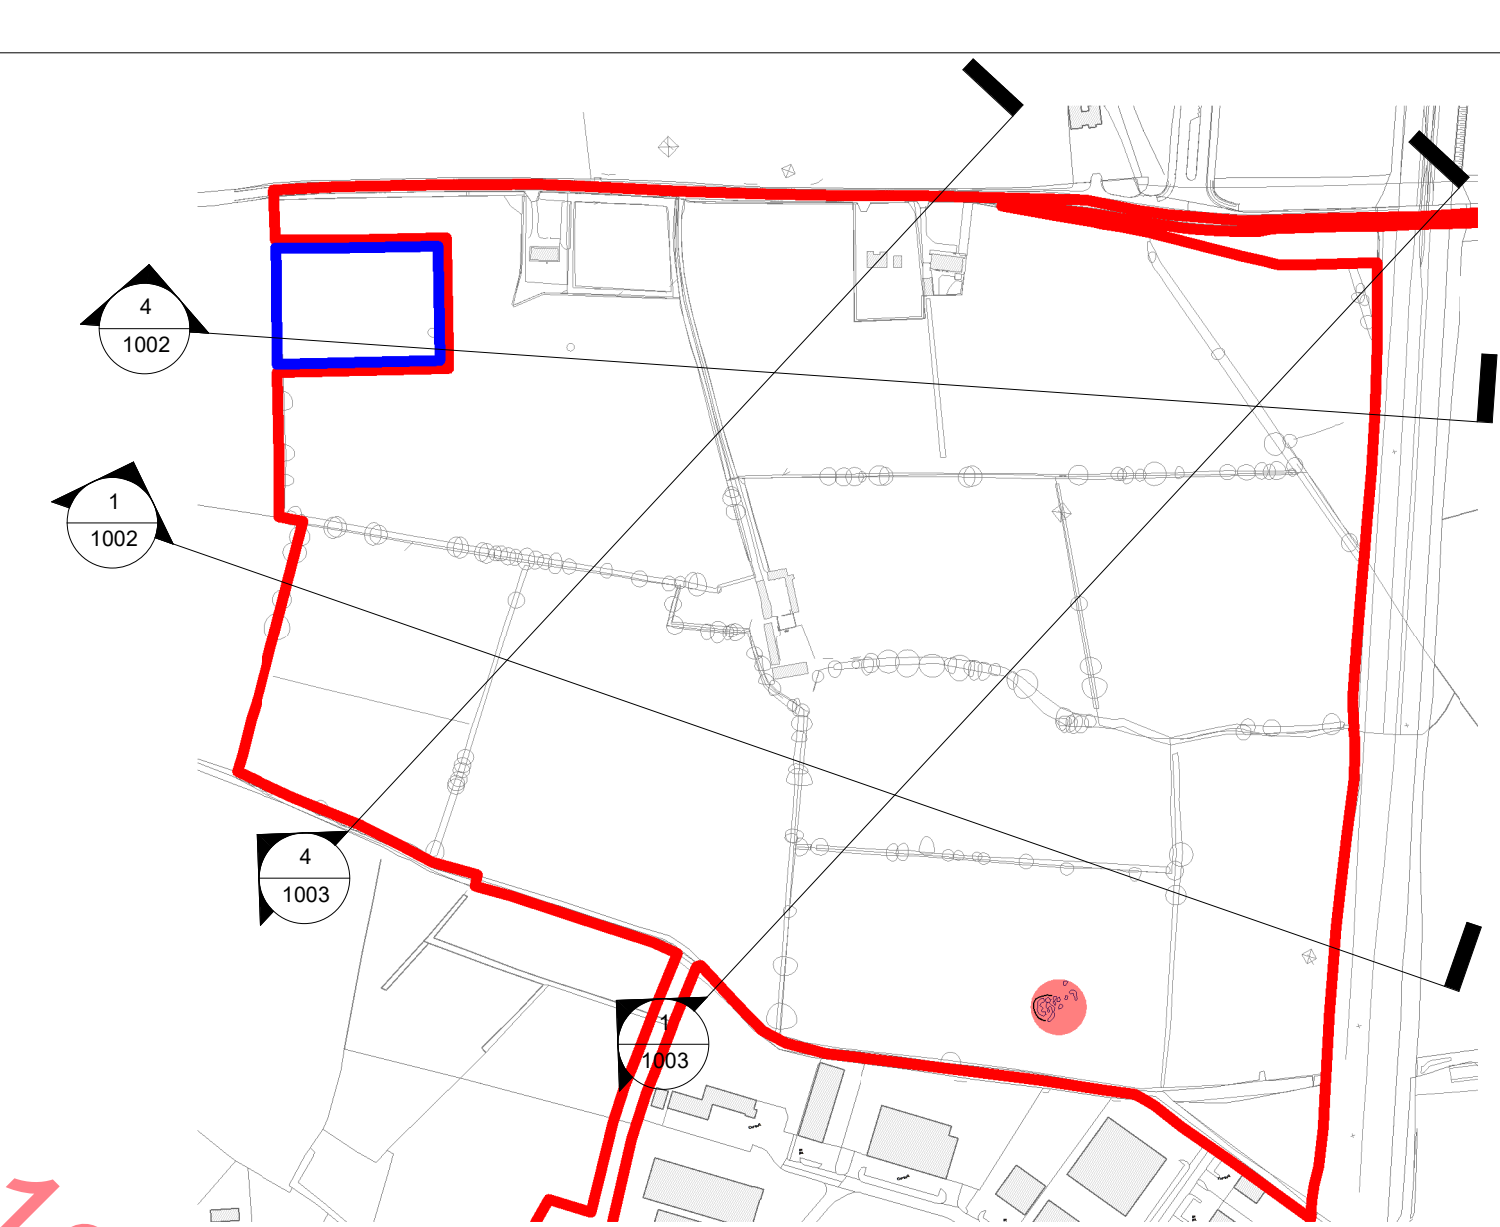